

SHEET NUMBER SHEET

TITLE SHEET

1A GENERAL NOTES

1B CONVENTIONAL SYMBOLS

1C-1 OVERALL EXISTING CONDITION SHEETS

ECS-1 THRU ECS-2 EXISTING CONDITIONS SURVEY

2C-1 SUMMARY SHEET


G&EC-1 THRU G&EC-4 GRADING & EROSION CONTROL PLANS & DETAILS

D-1 THRU D-4 SITE PLANS & DETAILS

L-1 THRU L-3 PLANTING PLANS AND DETAILS

X-1 THRU X-2 TYPICAL SECTIONS

BEAUFORT COUNTY, NC TOWN OF WASHINGTON PARK LIVING SILL

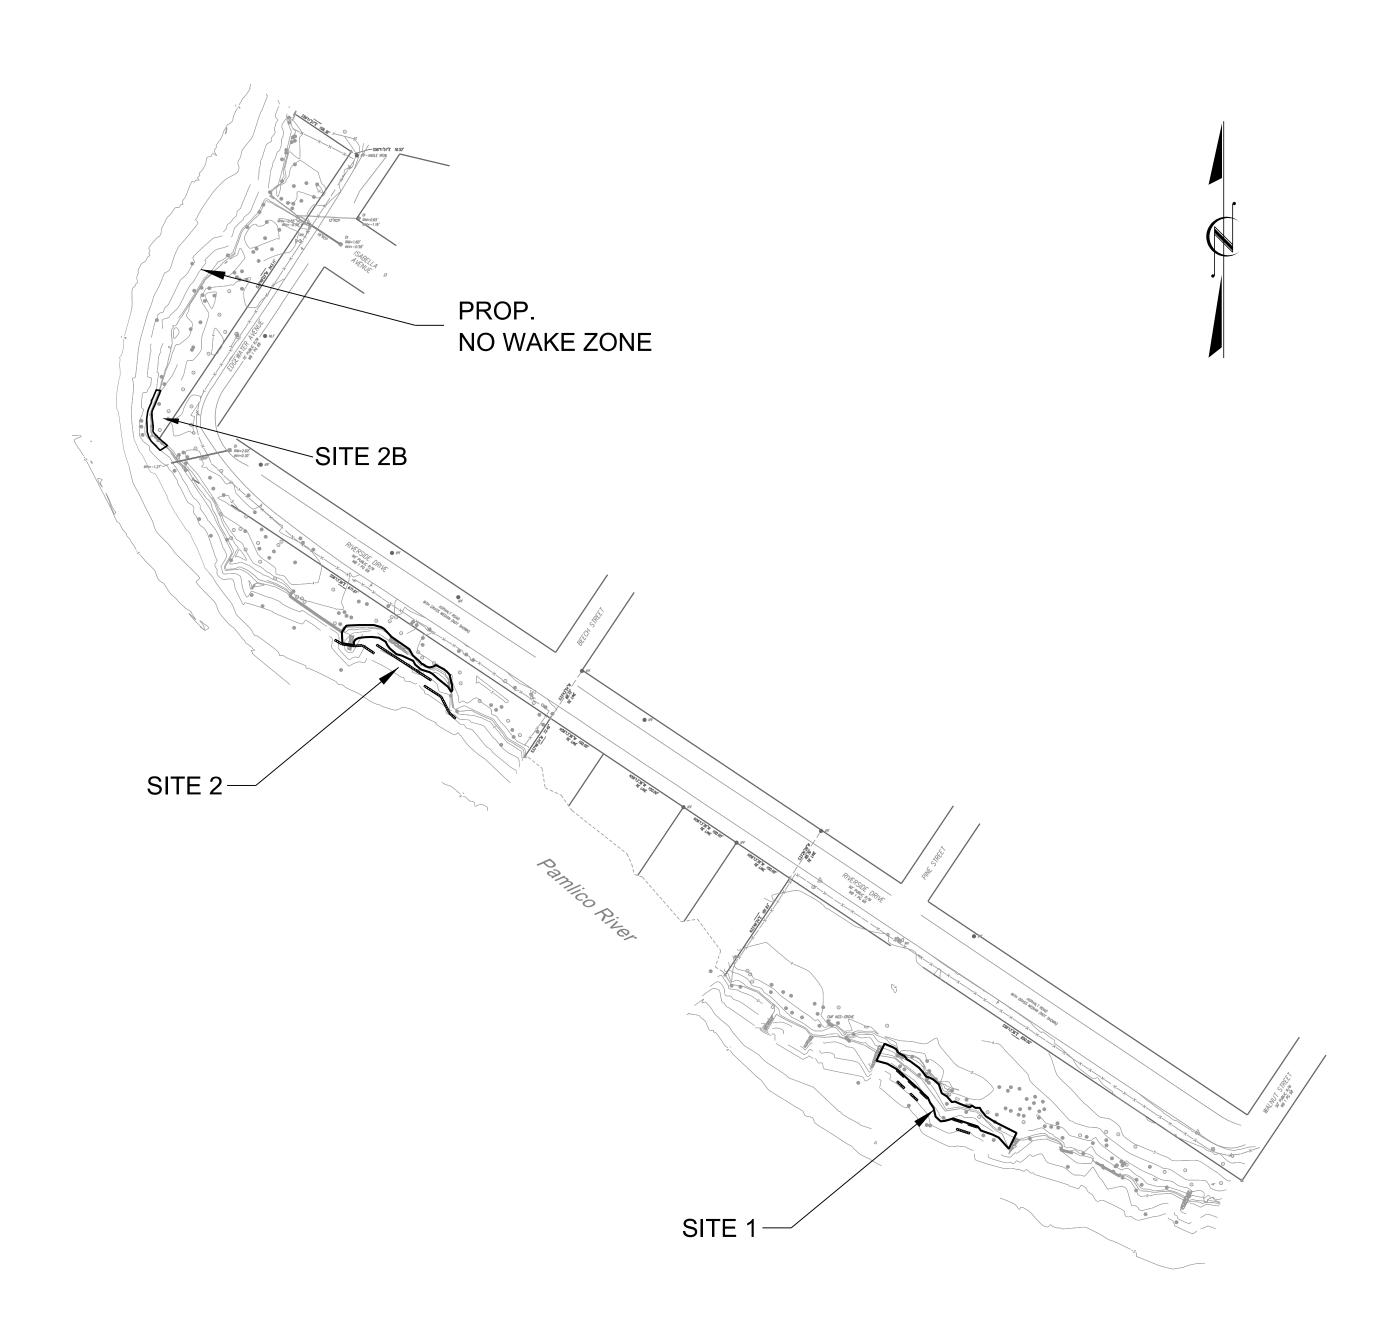







BEAUFORT COUNTY, NC TOWN OF WASHINGTON PAF

REVISIONS

DRAWN BY: CHECKED BY

TITLE SHEET

PRELIMINARY PLANS
DO NOT USE FOR CONSTRUCTION

GENERAL NOTES

- 1. ALL WORK SHALL BE PERFORMED IN ACCORDANCE WITH THE FOLLOWING STANDARDS: NORTH CAROLINA DEPARTMENT OF TRANSPORTATION "STANDARD SPECIFICATIONS FOR ROADS AND STRUCTURES" DATED JANUARY 2024, AND ANY SUPPLEMENTS THERETO ISSUED PRIOR TO THE RECEIPT OF BIDS.
- 2. ELEVATIONS ARE BASED ON NAVD-88 (NORTH AMERICAN VERTICAL DATUM). BENCHMARKS ARE SHOWN ON SHEET 1C-1.
- 3. SHOULD THE CONTRACTOR DISCOVER DISCREPANCIES BETWEEN THE PLANS AND THE ACTUAL FIELD CONDITIONS ENCOUNTERED, THE ENGINEER SHALL BE NOTIFIED IMMEDIATELY TO ARRIVE AT AN ACCEPTABLE SOLUTION.
- 4. SUBMITTALS ON MATERIALS FOR THIS PROJECT SHALL BE APPROVED BY THE ENGINEER PRIOR TO BEGINNING CONSTRUCTION.
- 5. EVERY EFFORT SHALL BE TAKEN TO MINIMIZE DISTURBANCE IN THE PROJECT AREA AND IN GAINING ACCESS TO/FROM THE WORK AREA.
- 6. THE GRADE LINE ELEVATIONS SHOWN DENOTE THE FINISHED ELEVATION OF THE PROPOSED OR FUTURE SURFACING AT GRADE POINTS SHOWN ON THE TYPICAL SECTION. GRADE LINES MAY BE ADJUSTED AT THEIR BEGINNING, ENDING AND AT STRUCTURES AS DIRECTED BY THE ENGINEER IN ORDER TO SECURE A PROPER TIE-IN OR TO CREATE A MORE "NATURAL APPEARANCE".
- 7. SILLS SHALL BE PLACED ONCE FILL HAS BEEN STABLIZED AND TURBIDITY CURTAIN HAS BEEN REMOVED.
- 9. ALL EXCESS MATERIAL MUST BE TRANSPORTED OFF SITE TO AN APPROPRIATE DISPOSAL AREA.
- 10. STOCKPILE AREAS, NOT DEFINED ON EC-1 ALL, SHALL BE APPROVED BY THE ENGINEER.
- 11. LIMIT OF DISTURBANCE DEFINED ON EC-1 REPRESENTS THE OFFSHORE LIMIT. THE CONTRACTOR SHALL PROPOSE A STABILIZED CONSTRUCTION ENTRANCE AND RESTORE ACCESS ROUTE TO PRE-CONSTRUCTION CONDITIONS PRIOR TO CLOSEOUT.
- 12. MARINE SAND SHALL BE PLACED IN AREAS OF FILL, UNLESS OTHERWISE REQUIED IN THE PLANS. NO AREA SHALL BE CUT.
- 13. UNACCEPTABLE PLANTS AND REPLACEMENT PLANTS REFER TO 1060-10. CONTRACTOR SHALL PROMPTLY REMOVE AND REPLACE PLANTS THAT HAVE BECOME UNACCEPTABLE DURING THE ESTABLISHMENT PHASE AS NEEDED OR AS DIRECTED. SEE SPECIAL PROVISION 4.
- 14. NO HEAVY EQUIPMENT IS PERMITTED BELOW MHHW. IF NECESSARY, CONTRACTOR SHALL ESTABLISH TEMPORARY ACCESS AREAS THAT SHALL BE APPROVED BY THE ENGINEER. TEMPORARY ACCESS AREAS SHALL NOT EXCEED A CUMULATIVE AREA OF 0.10 ACRES. NO TEMPORARY ACCESS SHALL BE APPROVED WITHIN THE EXISTING AREA OF WETLAND OR SAV.
- 15. HEAVY EQUIPMENT AND, IF USED, ANY CONSTRUCTION MATTING SHALL BE POWER-WASHED PRIOR TO ARRIVAL ON SITE TO AVOID AND MINIMIZE THE INTRODUCTION OF INVASIVE SPECIES.







Trotain Bearing Strain Strain

BEAUFORT COUNTY, NC FOWN OF WASHINGTON PA

REVISIONS

DRAWN BY: CHECKED BY
GSM DMK

GENERAL NOTES Note: Not to Scale

STATE OF NORTH CAROLINA, DIVISION OF HIGHWAYS CONVENTIONAL PLAN SHEET SYMBOLS

BOUNDARIES AND PROPERTY:	
State Line —	
County Line	
Township Line —	
City Line	
Reservation Line	
Property Line —	
Existing Iron Pin (EIP)	
Computed Property Corner ————	
Existing Concrete Monument (ECM)	<u></u>
Parcel / Sequence Number	
Existing Fence Line	
Proposed Woven Wire Fence	
Troposod Shair Zinik Forios	
Proposed Barbed Wire Fence	
Existing Wetland Boundary ——————	
Proposed Wetland Boundary —————	
Existing Endangered Animal Boundary ——	EAB
Existing Endangered Plant Boundary ——	ЕРВ ———
Existing Historic Property Boundary ——	НРВ ———
Known Contamination Area: Soil	—— - ⋙, — s — ⋙, — s —
Potential Contamination Area: Soil	
Known Contamination Area: Water	
Potential Contamination Area: Water ——	
Contaminated Site: Known or Potential —	
BUILDINGS AND OTHER CULTU	
Gas Pump Vent or U/G Tank Cap	
Sign —	
Well —	•
Small Mine	
Foundation —	
Area Outline	
Cemetery	
Building —	
School —	
Church —	— <u></u>
Dam —	
HYDROLOGY:	
Stream or Body of Water	
Hydro, Pool or Reservoir	
Jurisdictional Stream	
Buffer Zone 1	
Buffer Zone 2	—— BZ 2 ———
Flow Arrow ———————————————————————————————————	— <
Disappearing Stream ————————————————————————————————————	<u> </u>
Spring —	-0
Wetland	<u> </u>
Proposed Lateral, Tail, Head Ditch	

False Sump

RR Signal Milepost Switch RR Abandoned RR Dismantled RIGHT OF WAY & PROJECT CONTROL: Primary Horiz and Vert Control Point Secondary Horiz and Vert Control Point Vertical Benchmark Existing Right of Way Monument (Rebar and Cap) Proposed Right of Way Monument (Rebar and Cap) Proposed Permanent Easement Monument (Rebar and Cap) Existing Permanent Easement Monument (Rebar and Cap) Existing C/A Monument (Rebar and Cap) Existing Right of Way Line Proposed C/A Monument (Concrete) Existing Right of Way Line Proposed Right of Way Line Proposed Right of Way Line Existing Control of Access Line Proposed Row and CA Line Existing Control of Access Line Proposed Row and CA Line Existing Easement Line Proposed Temporary Construction Easement Proposed Permanent Drainage Easement Proposed Permanent Drainage Easement Proposed Permanent Utility Easement Proposed Permanent Utility Easement Proposed Permanent Utility Easement Proposed Row And ReLATED FEATURES: Existing Edge of Pavement Existing Curb Proposed Guiderail Existing Cable Guiderail	RAILROADS: Standard Gauge ———	
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Proposed Permanent Drainage Easement		
Proposed Permanent Drainage/Utility Easement ————————————————————————————————————		
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Proposed Guardrail Existing Cable Guiderail Proposed Cable Guiderail Equality Symbol Pavement Removal VEGETATION: Single Tree		
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Proposed Cable Guiderail Equality Symbol Pavement Removal VEGETATION: Single Tree		
Equality Symbol Pavement Removal VEGETATION: Single Tree		
Pavement Removal /EGETATION: Single Tree		A
VEGETATION:		
Single Tree		r ∨ ∨ ∨ ∨ ∨ \
		$\stackrel{\leftarrow}{\longleftrightarrow}$
Single Shrub ————	Single Tree Single Shrub	
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Orchard —	·
Vineyard	Vineyard
EXISTING STRUCTURES:	
MAJOR:	
Bridge, Tunnel or Box Culvert	CONC
Bridge Wing Wall, Head Wall and End Wall – MINOR:	- ) CONC WW (
Head and End Wall	CONC HW
Pipe Culvert —————	
Footbridge —	>
Drainage Box: Catch Basin, DI or JB ———	СВ
Paved Ditch Gutter	
Storm Sewer Manhole ————————————————————————————————————	(S)
Storm Sewer —	_
UTILITIES:	
* SUE - Subsurface Utility Engineering LOS - Level of Service - A,B,C or D (A	Accuracy)
Existing Power Pole ——————	•
Proposed Power Pole —————	$\forall$
Existing Joint Use Pole	
Proposed Joint Use Pole —————	
Power Manhole ————————————————————————————————————	_
Power Line Tower ————————————————————————————————————	
Power Transformer ———————————————————————————————————	M
U/G Power Cable Hand Hole ————	<u> </u>
TI-TTAITICT OIC	
U/G Power Line Test Hole (SUE - LOS A)* — U/G Power Line (SUE - LOS B)* — — —	
U/G Power Line (SUE - LOS C)*	
U/G Power Line (SUE - LOS D)*	
	·
TELEPHONE: Existing Telephone Pole ————	
Proposed Telephone Pole —————	
Telephone Manhole————————————————————————————————————	
Telephone Pedestal	
Telephone Cell Tower	<b>,</b>
U/G Telephone Cable Hand Hole ————————————————————————————————————	H _H <b>◆</b>
U/G Telephone Test Hole (SUE - LOS A)* — U/G Telephone Cable (SUE - LOS B)* ——	
U/G Telephone Cable (SUE - LOS C)*	
U/G Telephone Cable (SUE - LOS D)*	
,	
U/G Telephone Conduit (SUE - LOS B)*	
U/G Telephone Conduit (SUE - LOS C)*	
U/G Telephone Conduit (SUE - LOS D)*	
U/G Fiber Optics Cable (SUE - LOS B)*	
U/G Fiber Optics Cable (SUE - LOS C)*	
U/G Fiber Optics Cable (SUE - LOS D)* ——	T FO

WATER:		DDE
Water Manhole ————	W	0/4/0
Water Meter —	0	۵
Water Valve ————	$\otimes$	
Water Hydrant —————	⋄	
U/G Water Line Test Hole (SUE - LOS A)* —	•	
U/G Water Line (SUE - LOS B)*	w	
U/G Water Line (SUE - LOS C)*		
U/G Water Line (SUE - LOS D)*		
Above Ground Water Line ————	A/G Water	
TV:		
TV Pedestal	C	
TV Tower —	$\otimes$	
U/G TV Cable Hand Hole —————	HH	
U/G TV Test Hole (SUE - LOS A)*		
U/G TV Cable (SUE - LOS B)*		
U/G TV Cable (SUE - LOS C)*		
U/G TV Cable (SUE - LOS D)*	Tv	
U/G Fiber Optic Cable (SUE - LOS B)*	TV F0	
U/G Fiber Optic Cable (SUE - LOS C)*	—— — TV FO— ——	
U/G Fiber Optic Cable (SUE - LOS D)* ——	TV FO	
GAS:		
Gas Valve ————	$\Diamond$	
Gas Meter ————	$\Diamond$	
U/G Gas Line Test Hole (SUE - LOS A)* —		
U/G Gas Line (SUE - LOS B)*		
U/G Gas Line (SUE - LOS C)*		
U/G Gas Line (SUE - LOS D)*	G	
Above Ground Gas Line ————	A/G Gas	
SANITARY SEWER:		
Sanitary Sewer Manhole —————	<b>(h)</b>	
Sanitary Sewer Cleanout —————	<b>(±)</b>	
U/G Sanitary Sewer Line ————	ss	
Above Ground Sanitary Sewer	A/G Sanitary Sewer	
SS Force Main Line Test Hole (SUE - LOS A)*		
SS Force Main Line (SUE - LOS B)*	— — — FSS— — — –	
SS Force Main Line (SUE - LOS C)*	——————————————————————————————————————	
SS Force Main Line (SUE - LOS D)*	FSS	
MISCELLANEOUS:		
Utility Pole —————	•	_
Utility Pole with Base	$\overline{\cdot}$	_
Utility Located Object	$\odot$	_
Utility Traffic Signal Box —————	S	_
Utility Unknown U/G Line (SUE - LOS B)* —		_
U/G Tank; Water, Gas, Oil ————		
Underground Storage Tank, Approx. Loc.——	(UST)	
A/G Tank; Water, Gas, Oil —————		
Geoenvironmental Boring —	<b>←</b>	
Abandoned According to Utility Records ——	AATUR	
End of Information		








EAUFORT COUNTY, NC N OF WASHINGTON PAR

CONVENTIONAL SYMBOLS

1B

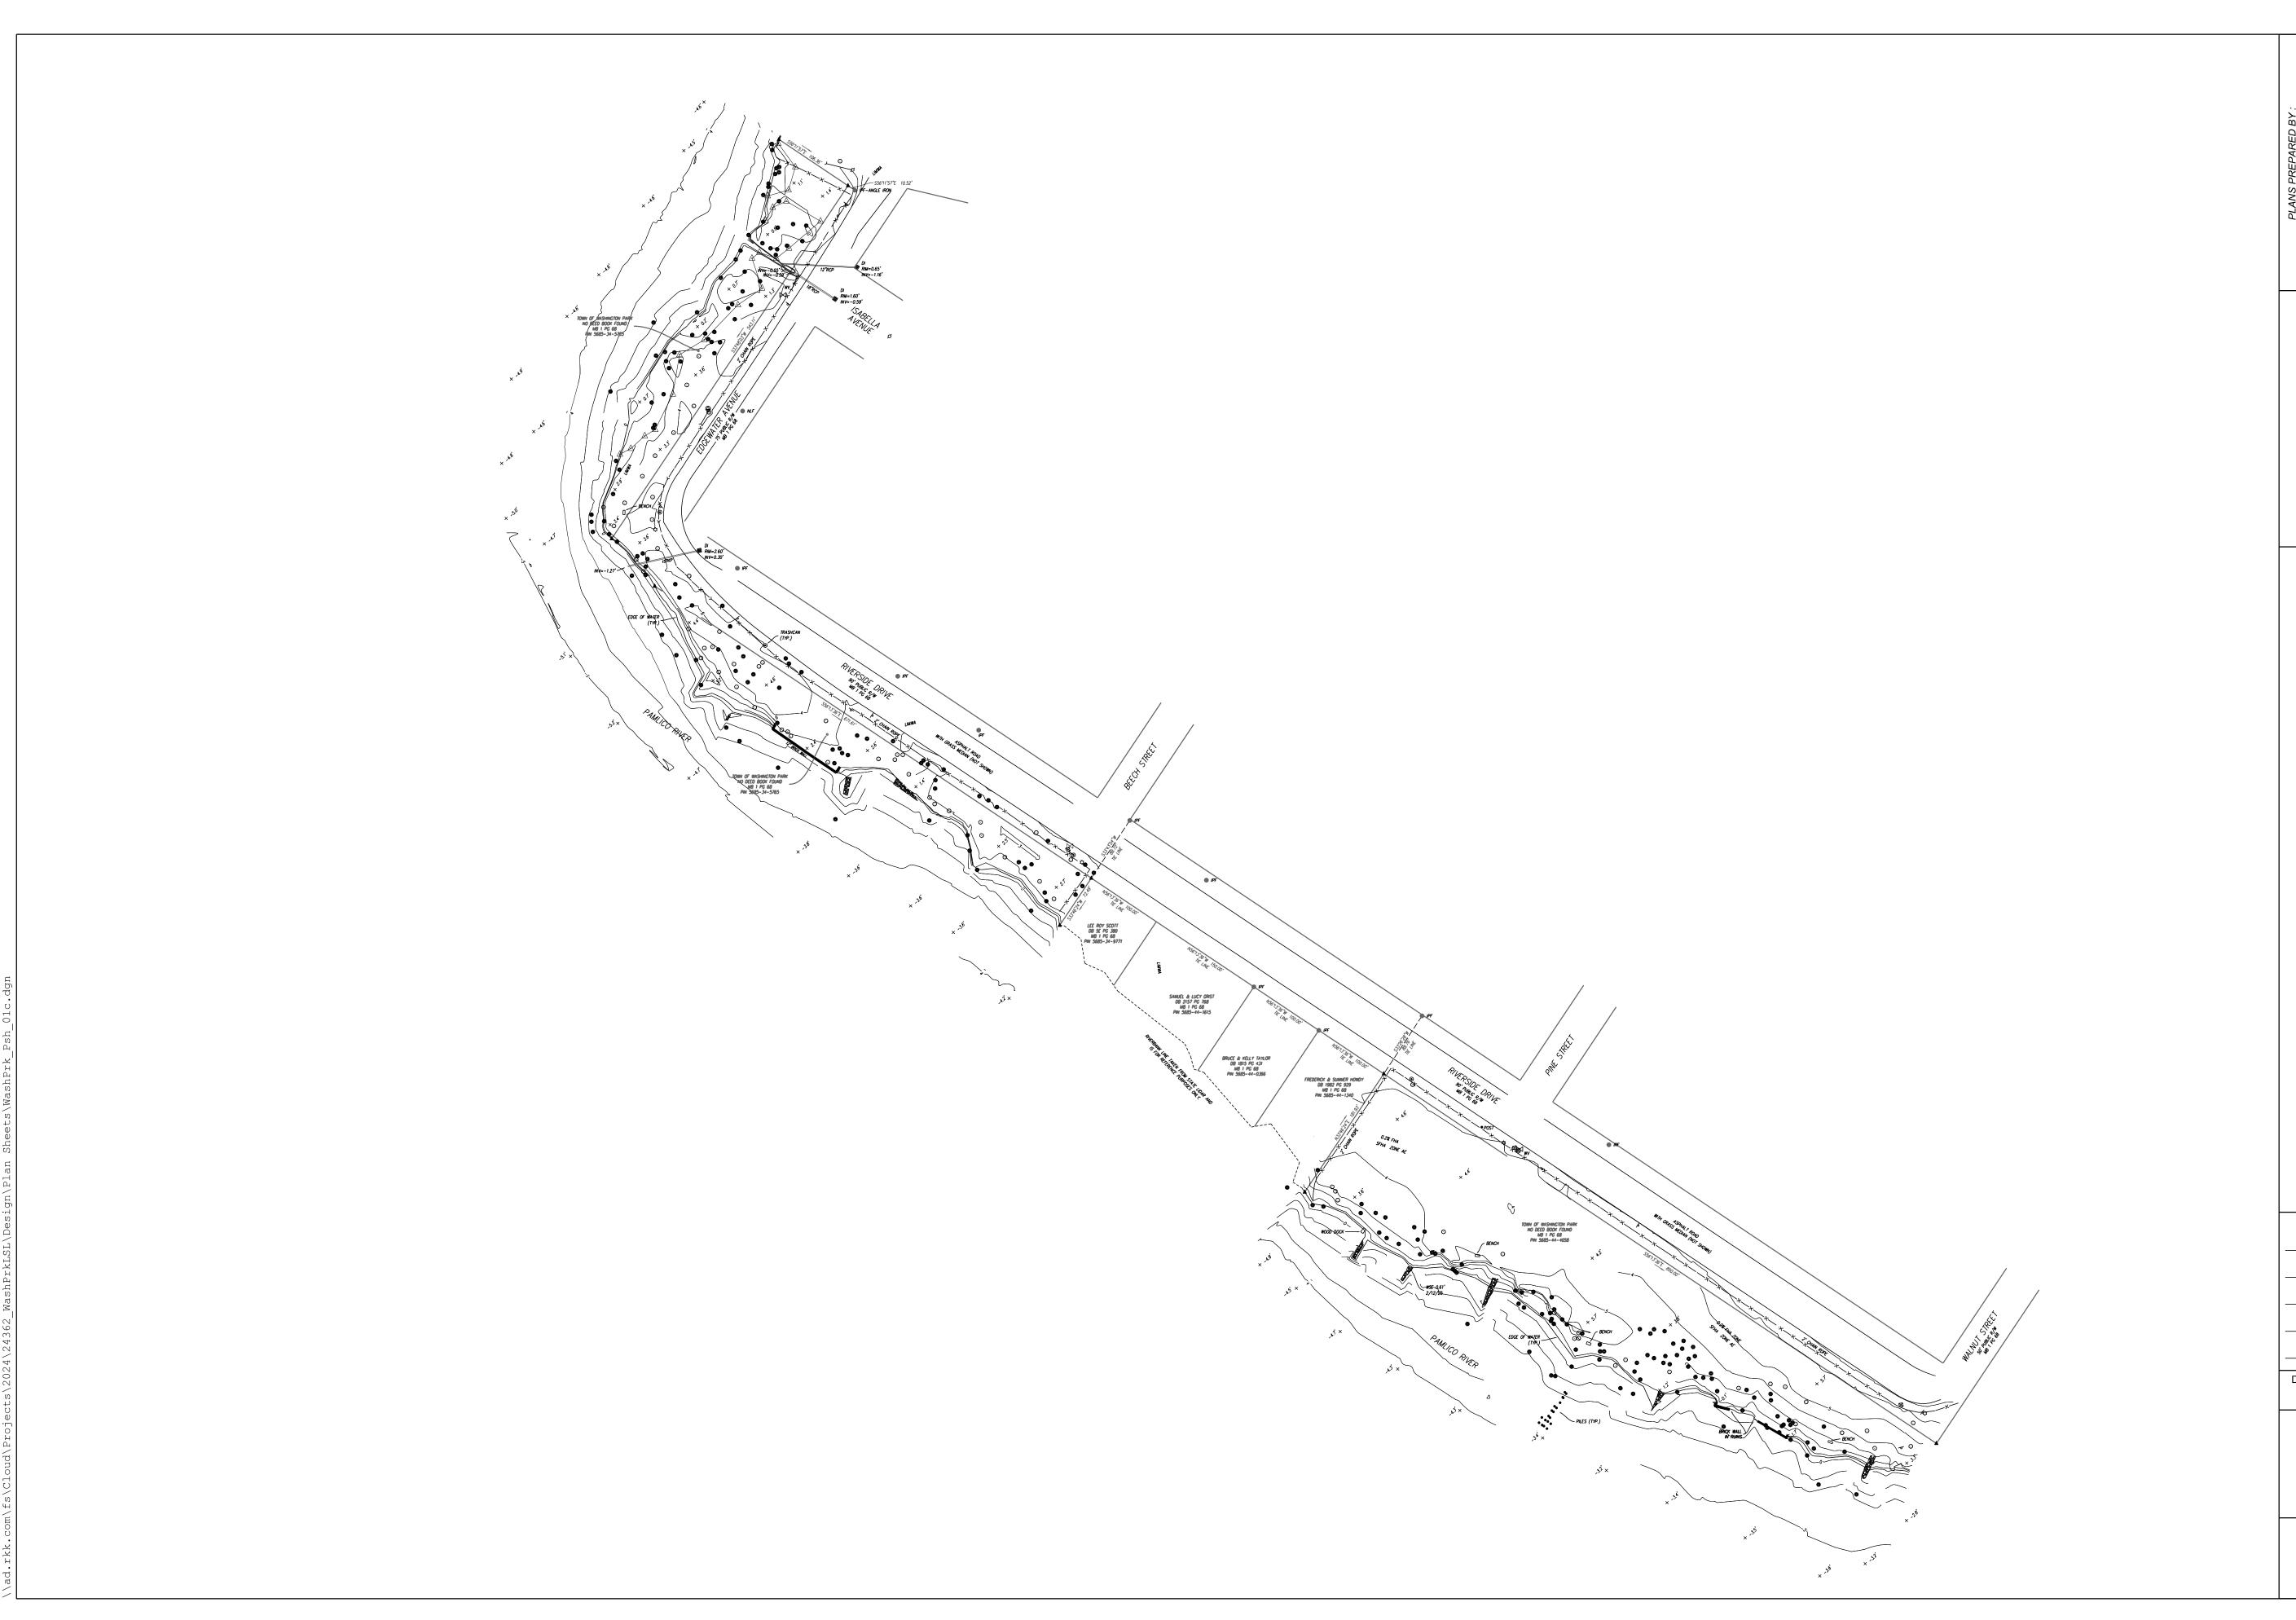




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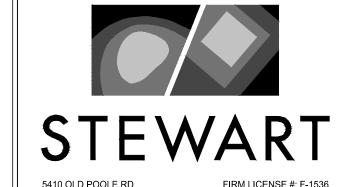
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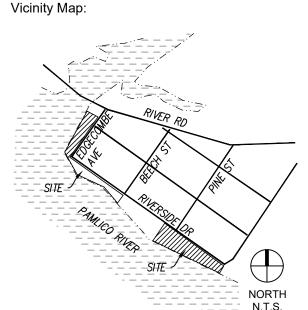
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GSM DMK

OVERALL EXISTING CONDITIONS


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SCALE: 1" = 50'

**EXISTING CONDITIONS SURVEY FOR:** 

### WASHINGTON PARK

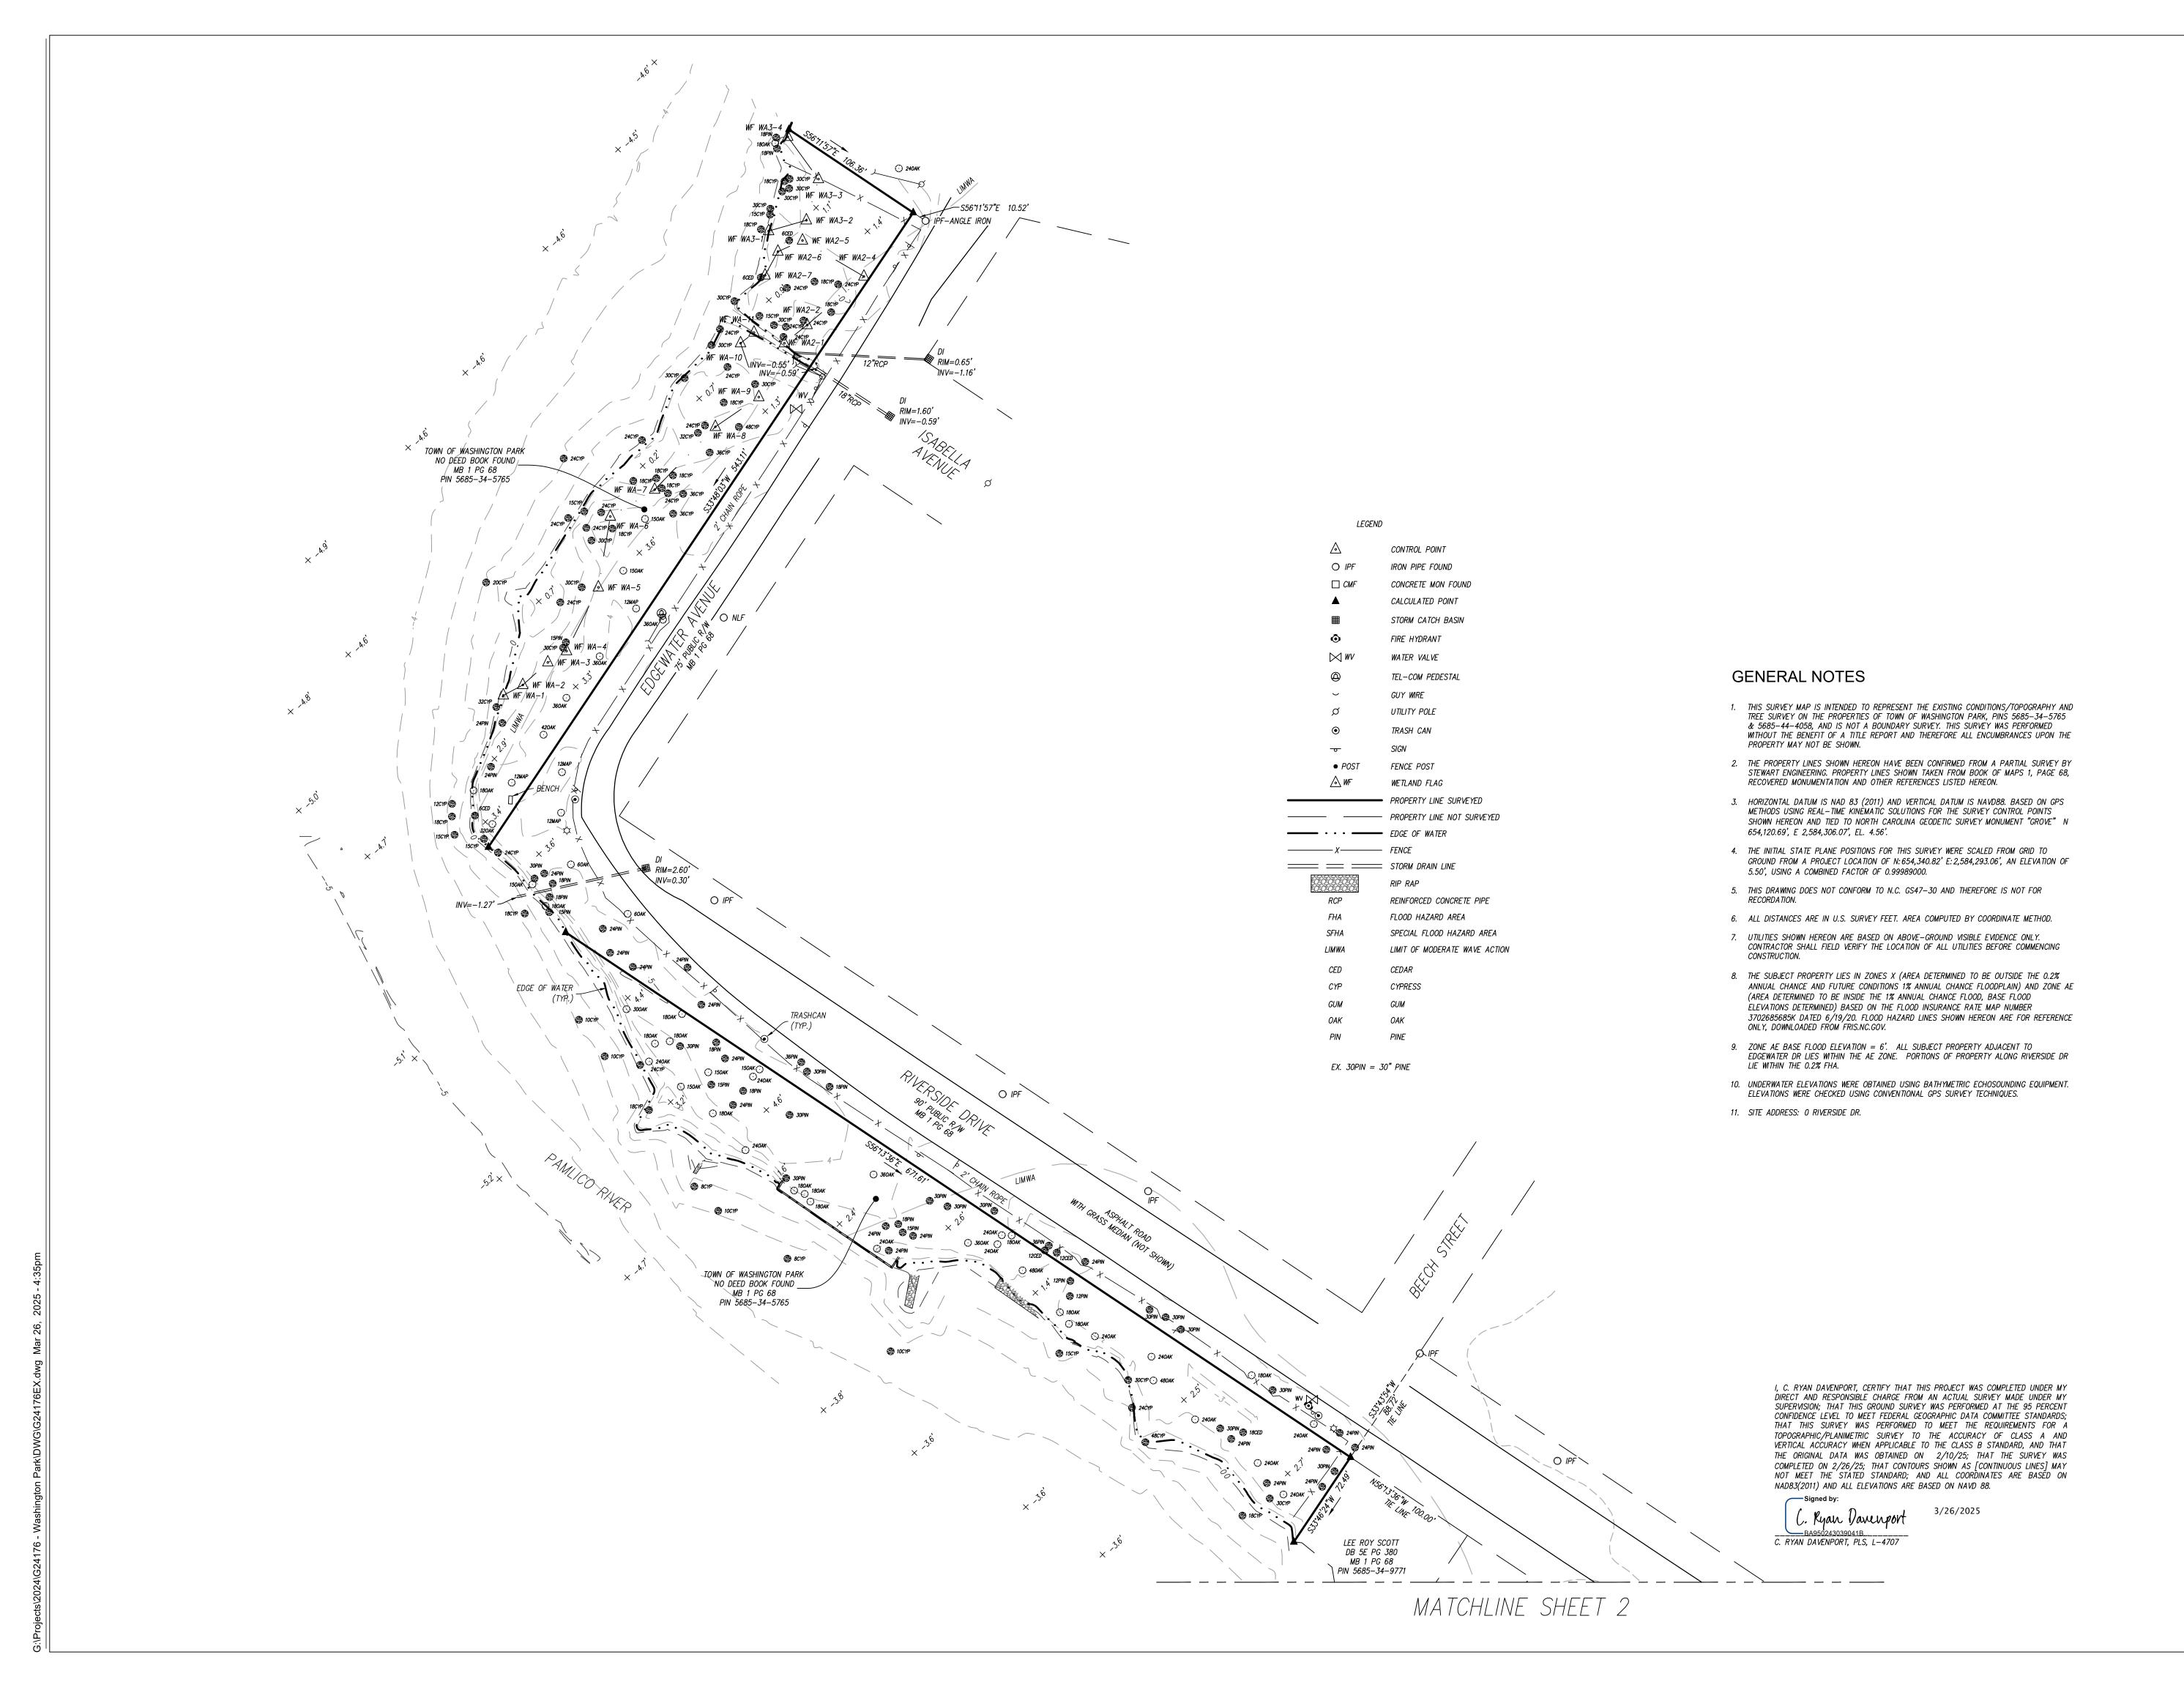TOWN OF WASHINGTON PARK BEAUFORT COUNTY, NORTH CAROLINA DATE: 3/20/25 SCALE: 1"=50' CONTOUR INTERVAL = 1 FOOT PREPARED FOR: RK&K

Revisions: No. Date Description

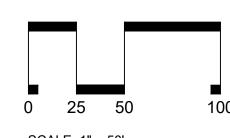


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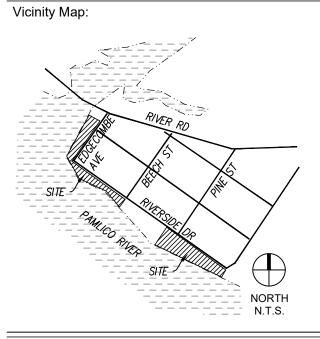
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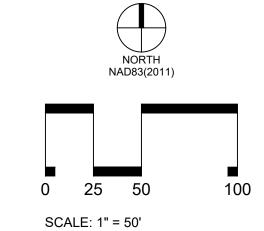
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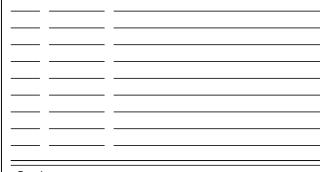



### **EXISTING CONDITIONS SURVEY FOR:**

### WASHINGTON PARK

TOWN OF WASHINGTON PARK BEAUFORT COUNTY, NORTH CAROLINA DATE: 3/20/25 SCALE: 1"=50' CONTOUR INTERVAL = 1 FOOT PREPARED FOR: RK&K

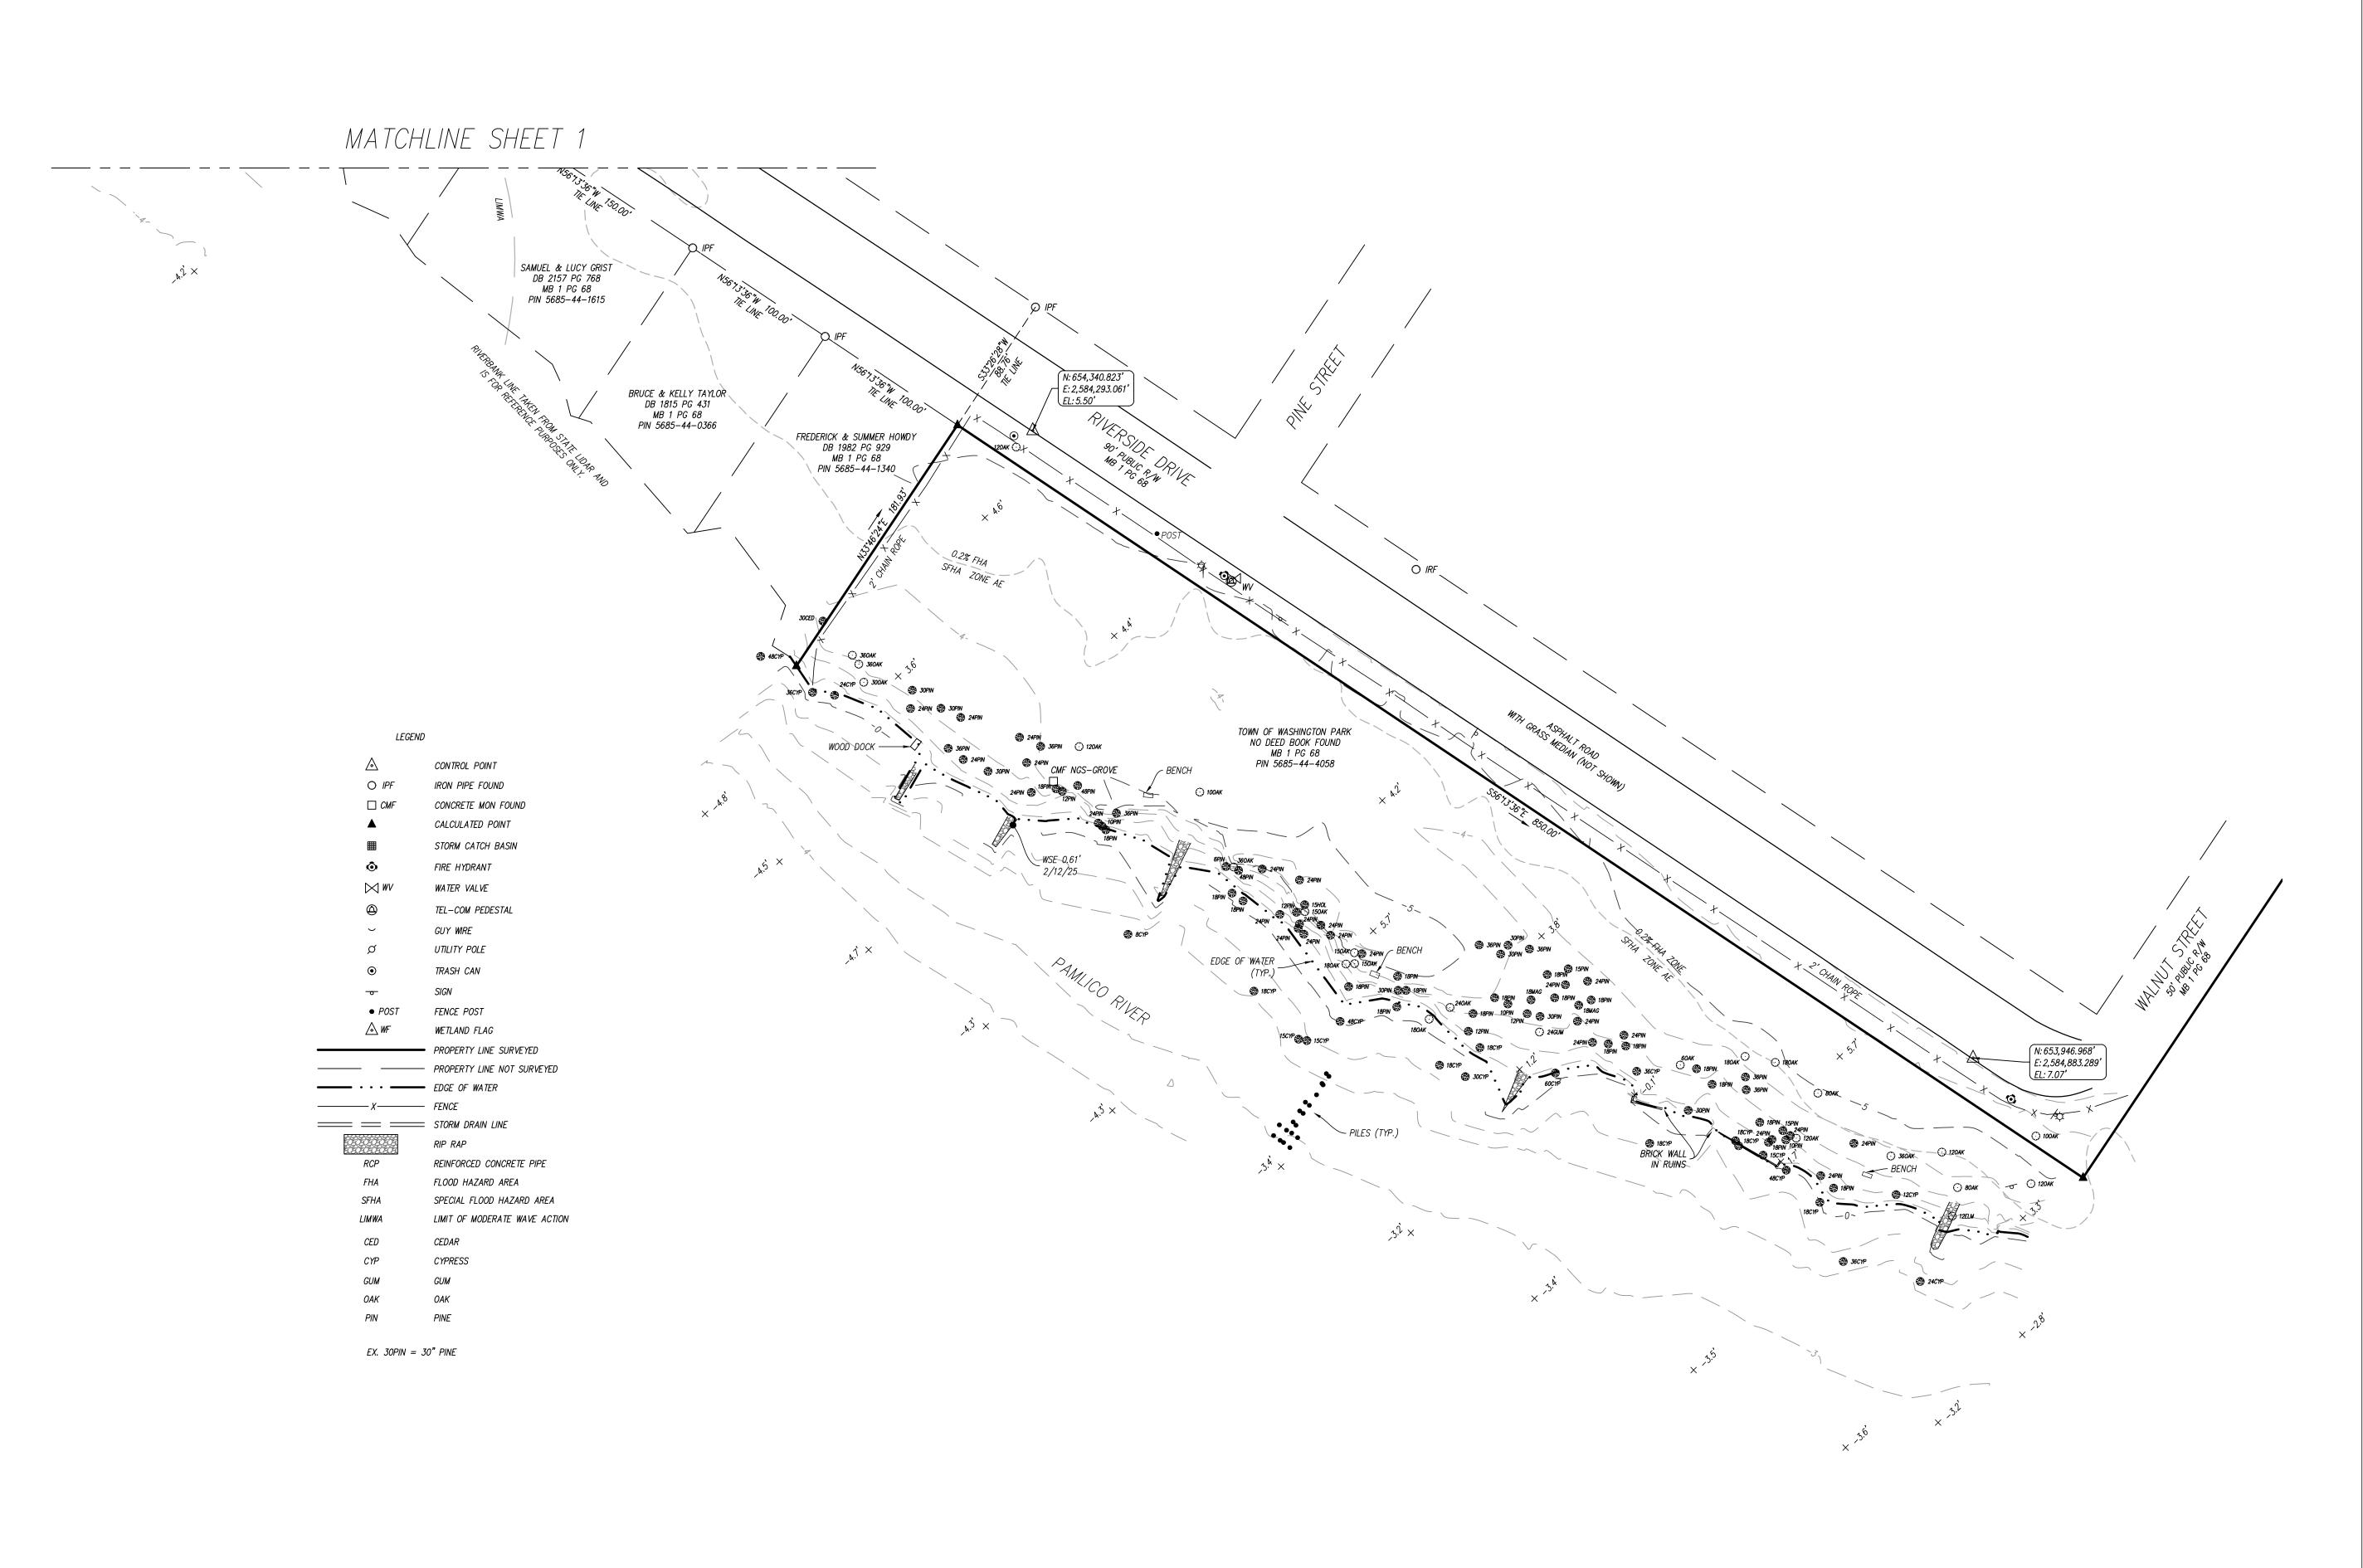Revisions:



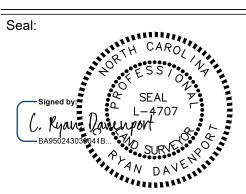

CRD CRD 2 of 2

## SUMMARY OF QUANTITIES SHEET





# BEAUFORT COUNTY, NC TOWN OF WASHINGTON PARK MARSH SILL


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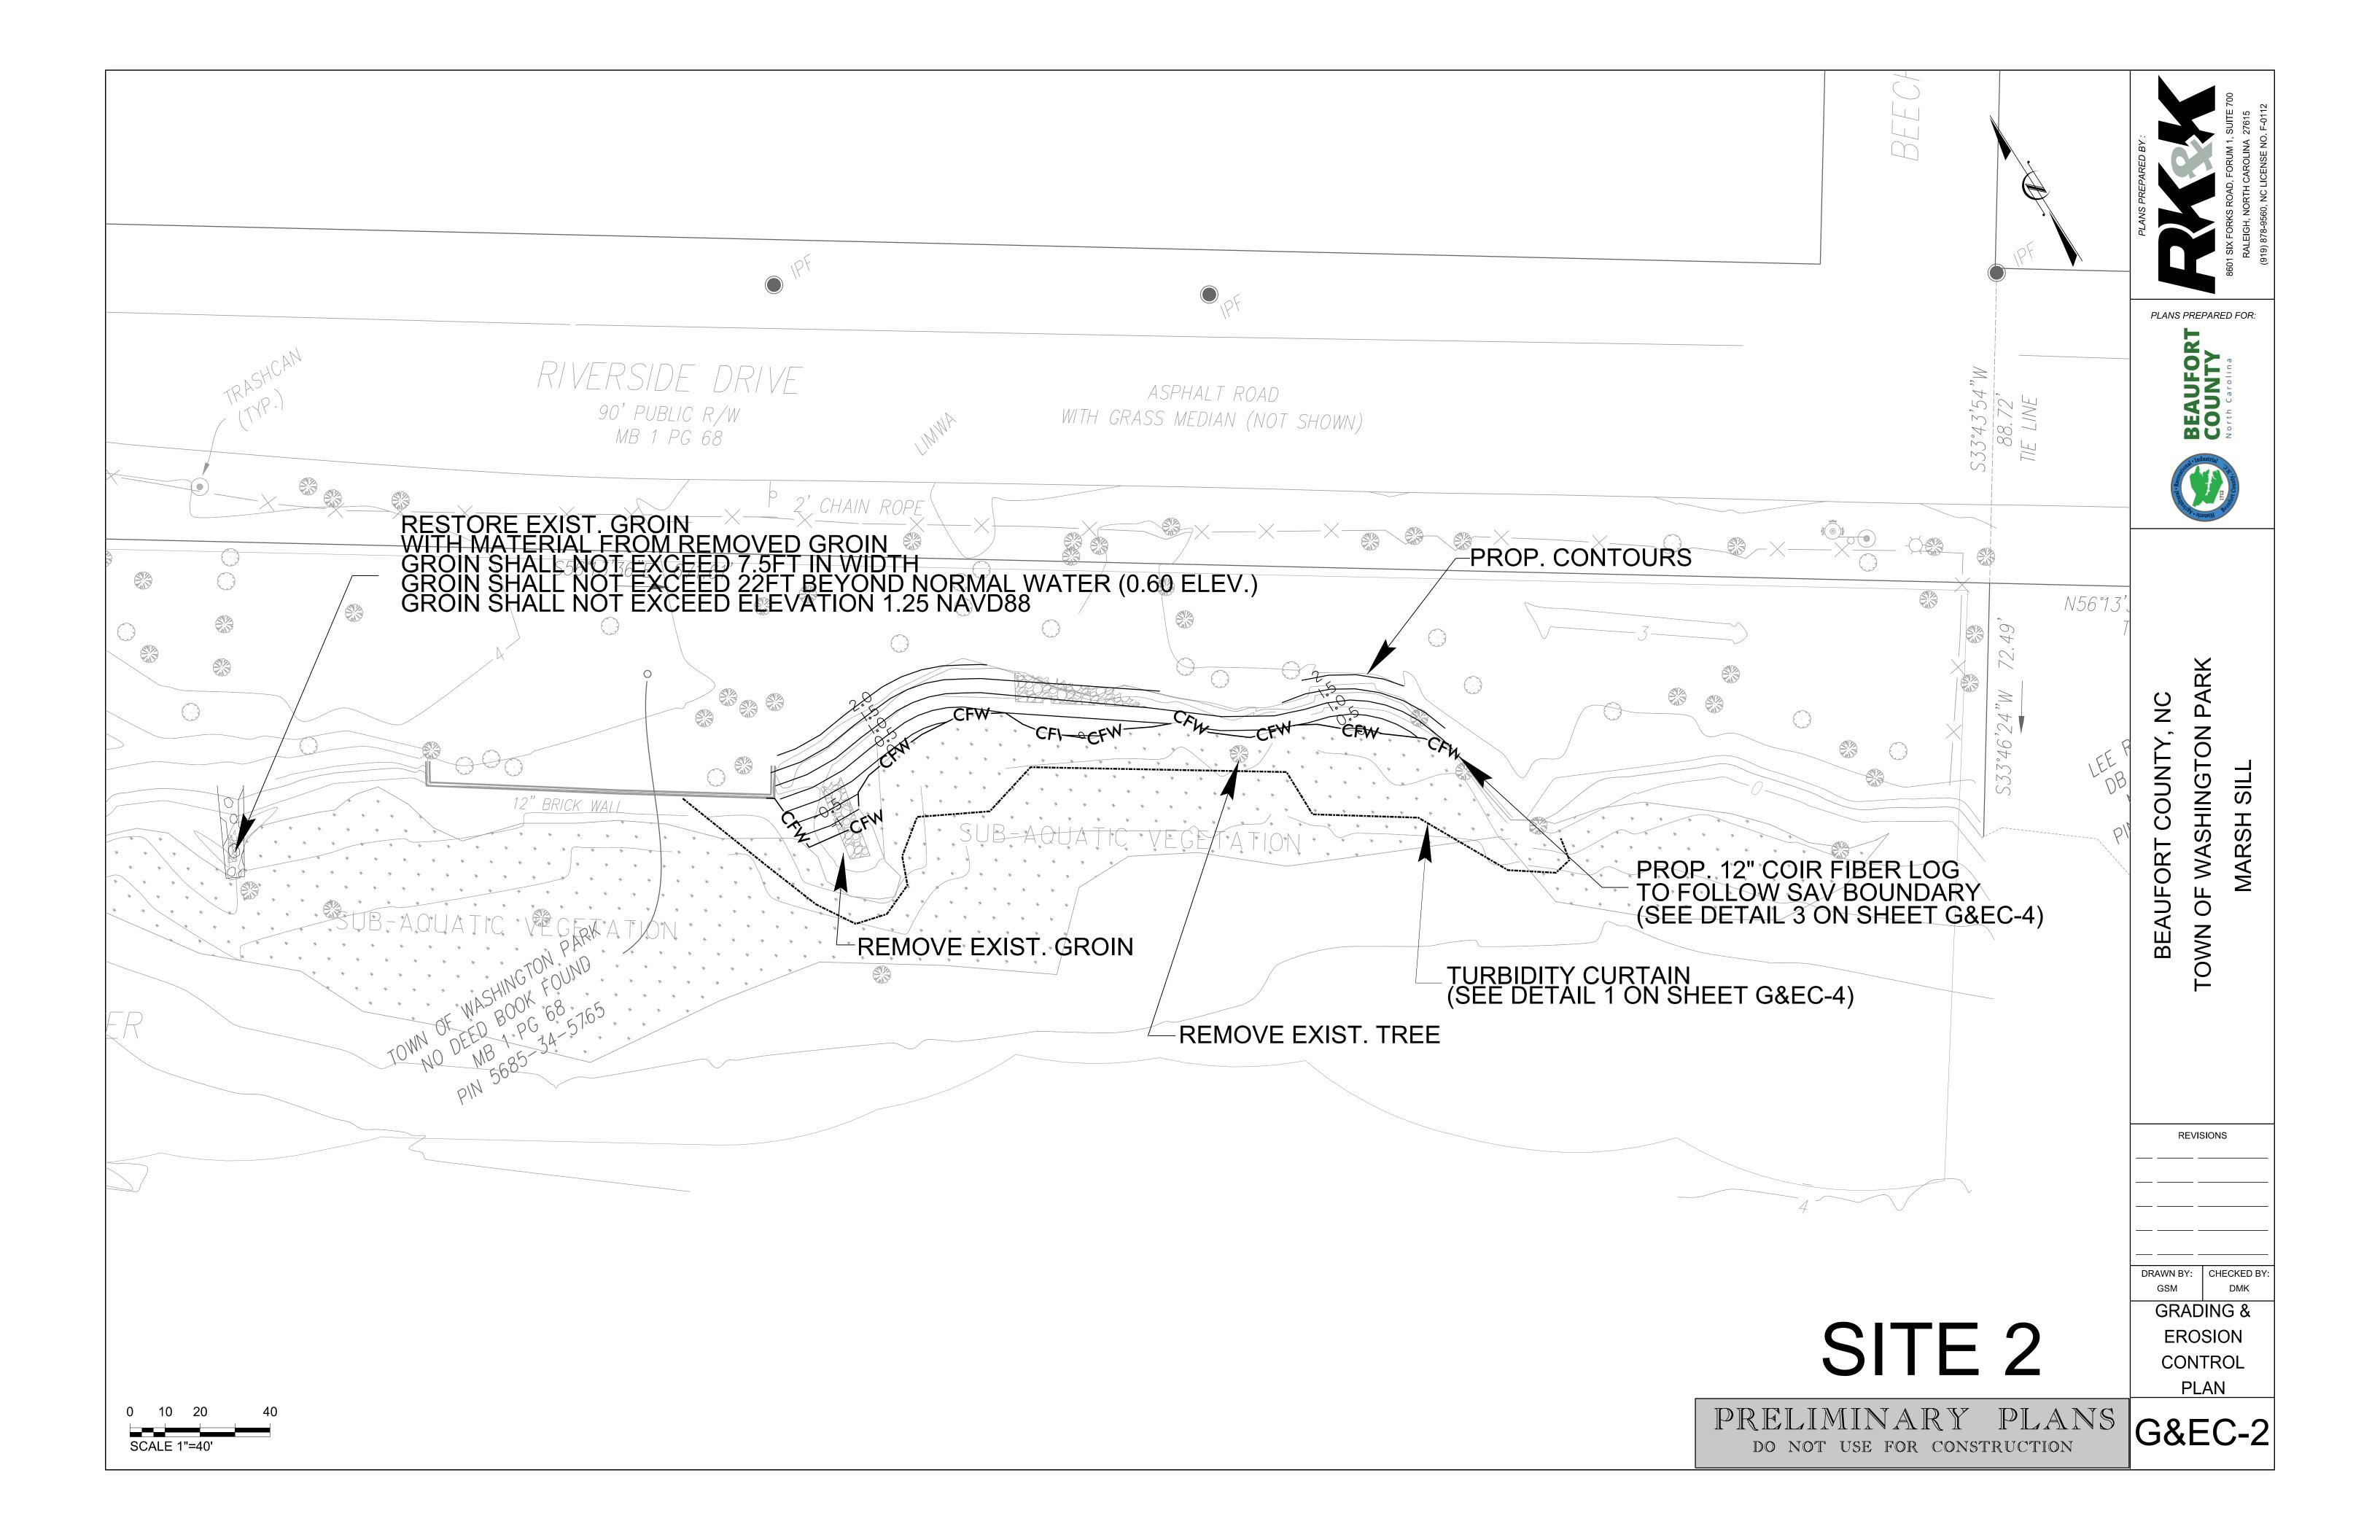
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CHECKED BY:
DMK

SUMMARY
OF
QUANTITIES

2



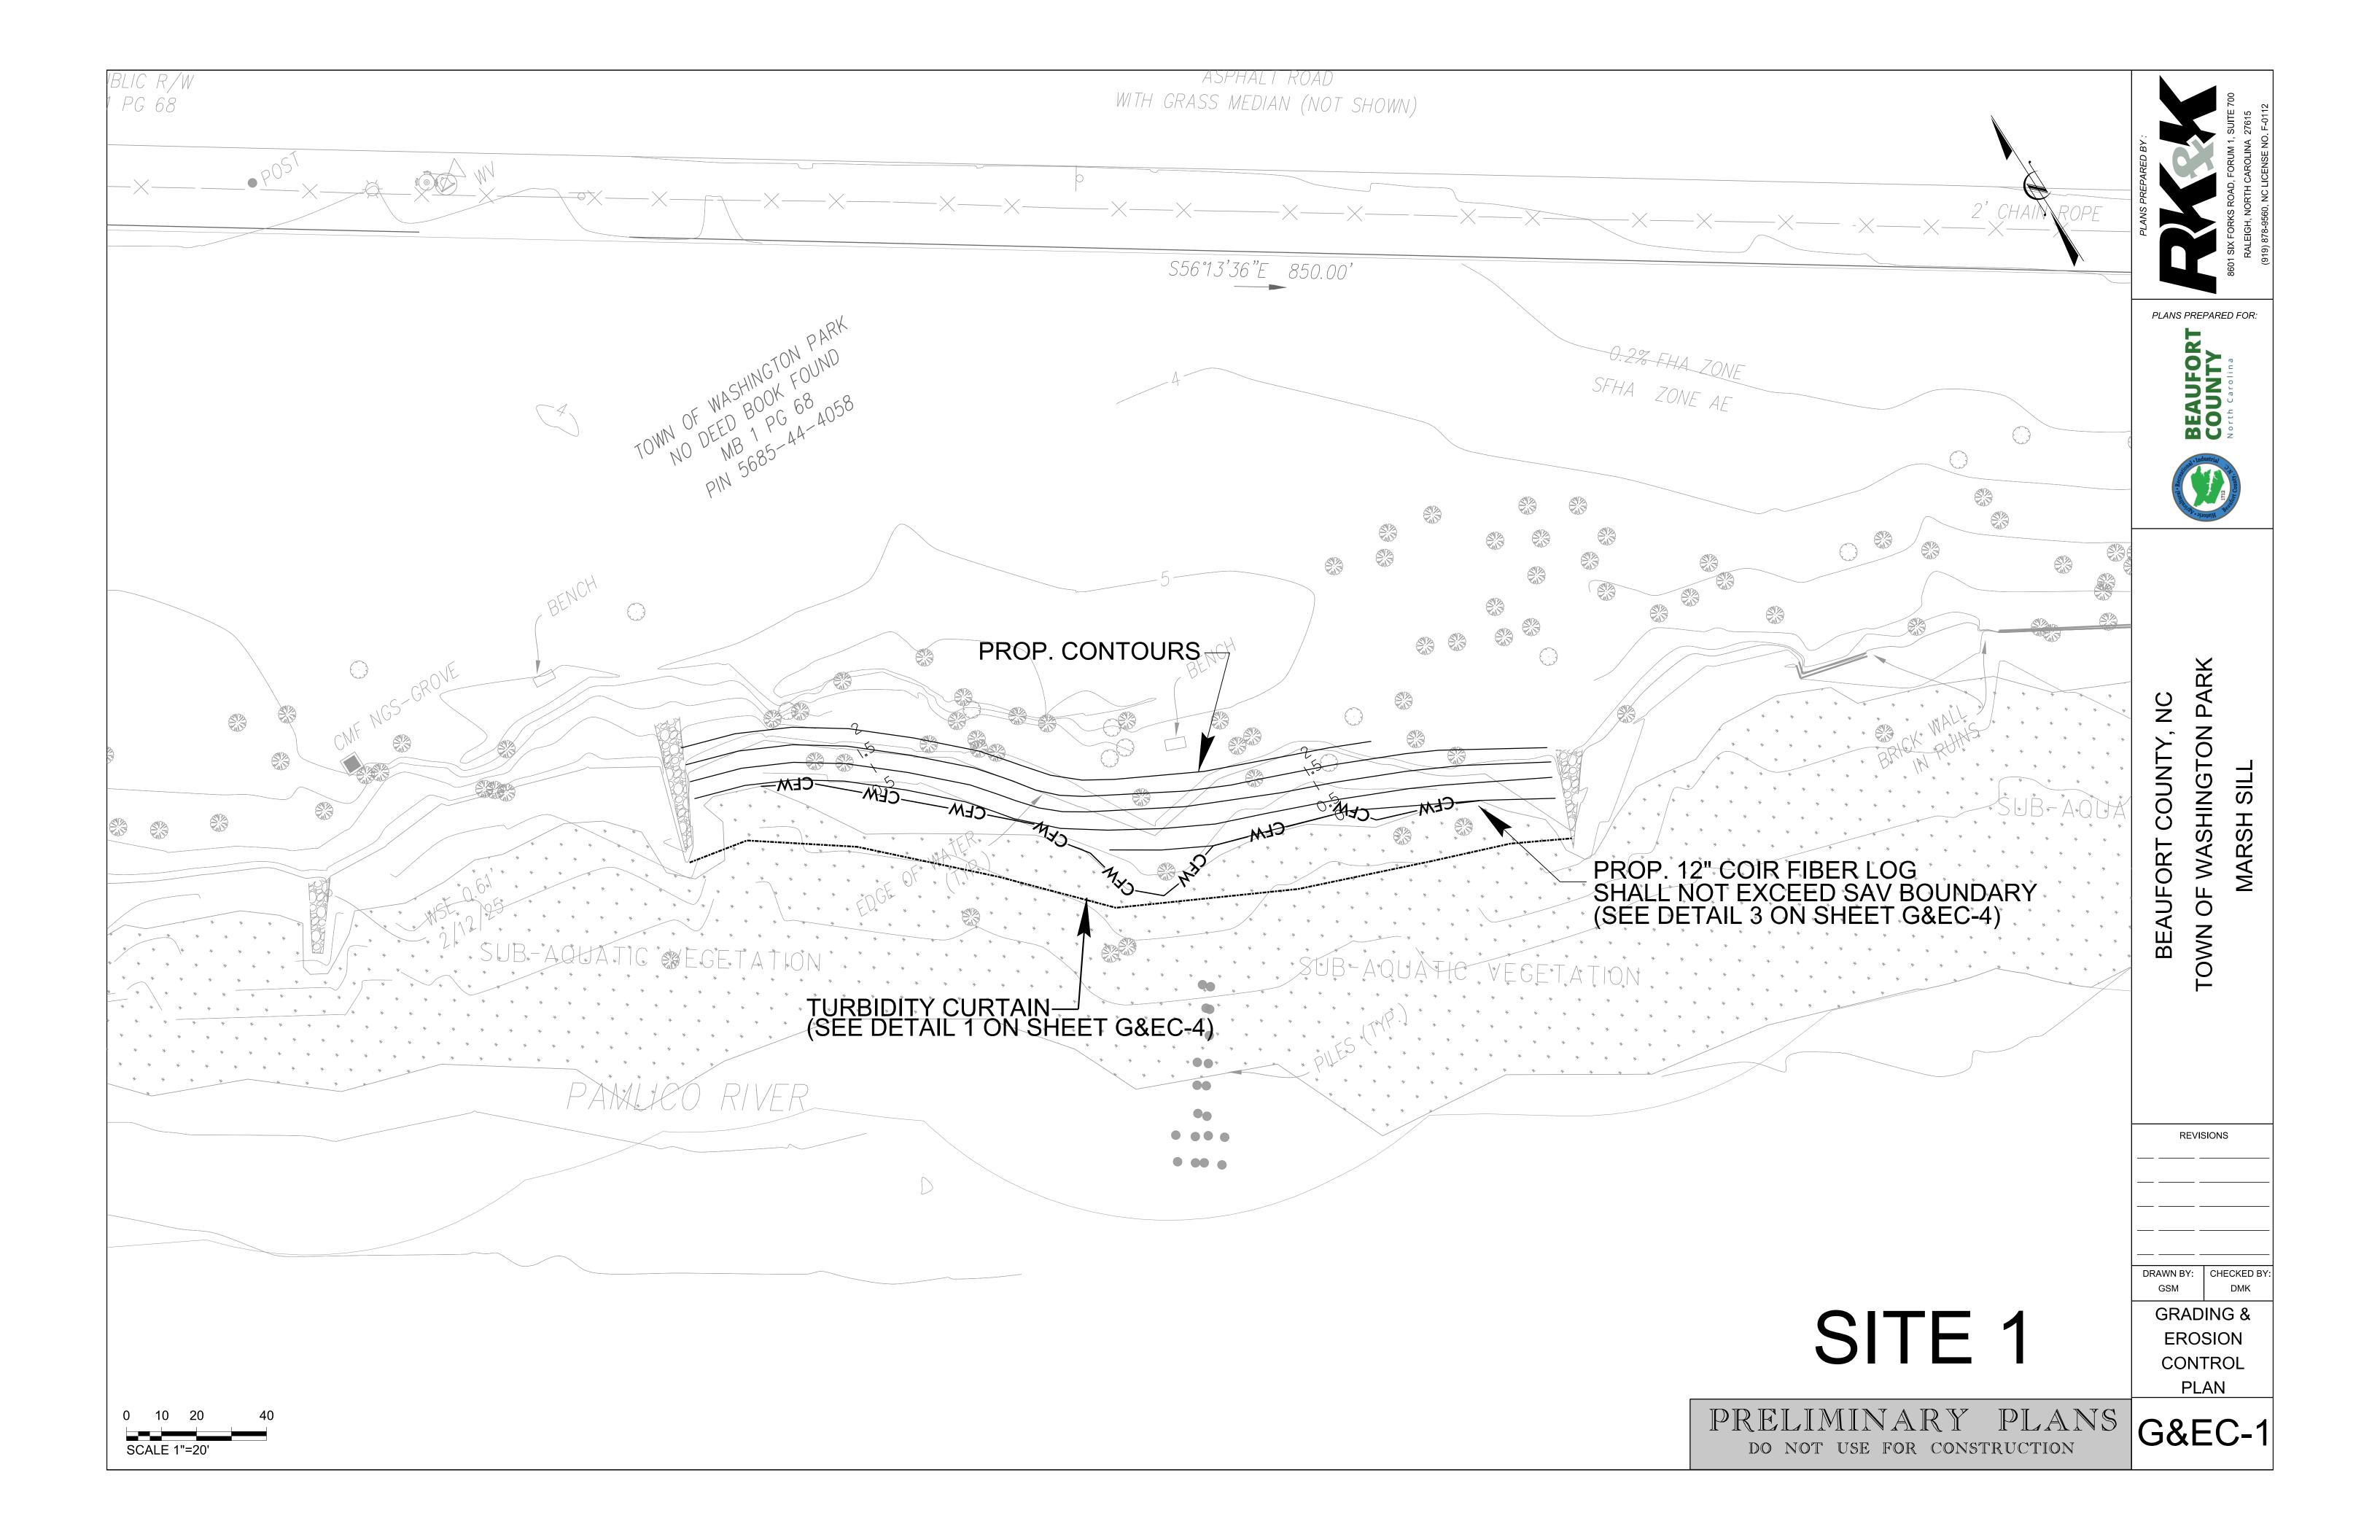

### EROSION CONTROL NOTES

- 1. ERECTION OF SEDIMENTATION AND EROSION CONTROL MEASURES SHALL BE IN ACCORDANCE WITH STATE EROSION CONTROL REGULATIONS.
- 2. THE CONTRACTOR SHALL INSTALL AND MAINTAIN THROUGHOUT THE PROJECT CONSTRUCTION ALL EROSION CONTROL MEASURES SHOWN WITHIN THESE PLANS AND IN ACCORDANCE WITH APPLICABLE NCDEQ EROSION AND SEDIMENT CONTROL REGULATIONS. THE CONTRACTOR MAY ADJUST LOCATION OF MEASURES AS NECESSARY PROVIDED CHANGES HAVE BEEN APPROVED BY THE ENGINEER.
- 3. ALL CONTROL MEASURES SHALL BE CHECKED, AND REPAIRED AS NECESSARY, MONTHLY IN DRY PERIODS, AND WITHIN 24 HOURS AFTER RAINFALL AT THE SITE OF 0.75 INCHES OR GREATER WITHIN A 24 HOUR PERIOD. THE PERMITTEE SHALL MAINTAIN WRITTEN RECORDS OF SUCH CHECKS AND REPAIRS ON SITE AT ALL TIMES.
- 4. A TURBIDITY CURTAIN SHOULD BE LOCATED BETWEEN THE PROJECT WORK AREA AND WATERWAY.
- 5. ALL DISTURBED AREAS THAT ARE NOT OTHERWISE STABILIZED SHALL BE TEMPORARILY OR PERMANENTLY SEEDED IN ACCORDANCE WITH THE NORTH CAROLINA SEDIMENT CONTROL REGULATIONS. PERMANENT SEEDING AND VEGETATION ESTABLISHMENT IS REQUIRED PRIOR TO PROJECT COMPLETION AND ACCEPTANCE.
- 6. CONSTRUCTION ENTRANCES INSTALLED AT ACCESS LOCATIONS SHALL BE MAINTAINED AS REQUIRED TO PREVENT SILT/SEDIMENT FROM LEAVING THE SITE. THIS INCLUDES, BUT IS NOT LIMITED TO, WASH DOWN OF THE CONSTRUCTION ENTRANCE, INSTALLING AND UTILIZING A VEHICLE WASH DOWN AREA, INSTALLING ADDITIONAL STONE, ETC.
- 7. DURING CONSTRUCTION OF THE PROJECT, SOIL STOCKPILES SHALL BE STABILIZED OR PROTECTED WITH SEDIMENT TRAPPING MEASURES. THE CONTRACTOR IS RESPONSIBLE FOR TEMPORARY PROTECTION AND PERMANENT STABILIZATION OF ALL SOIL STOCKPILES ON SITE AS WELL AS SOIL INTENTIONALLY TRANSPORTED FROM THE PROJECT SITE.
- 8. THE CONTRACTOR IS RESPONSIBLE FOR KEEPING MUD AND DEBRIS OFF CITY/STATE STREETS AND ROW. CLEANUP IS REQUIRED DAILY.
- 9. ALL TEMPORARY MEASURES SHALL BE REMOVED ONCE ACCEPTABLE PERMANENT STABILIZATION IS ACHIEVED. THE ENGINEER SHALL DETERMINE IF THE PERMANENT STABILIZATION IS ACCEPTABLE.

### LEGEND

----- CFW--- COIR FIBER LOG
----- TURBIDITY CURTAIN









BEAUFORT COUNTY, NC
TOWN OF WASHINGTON PARK
MARSH SILL


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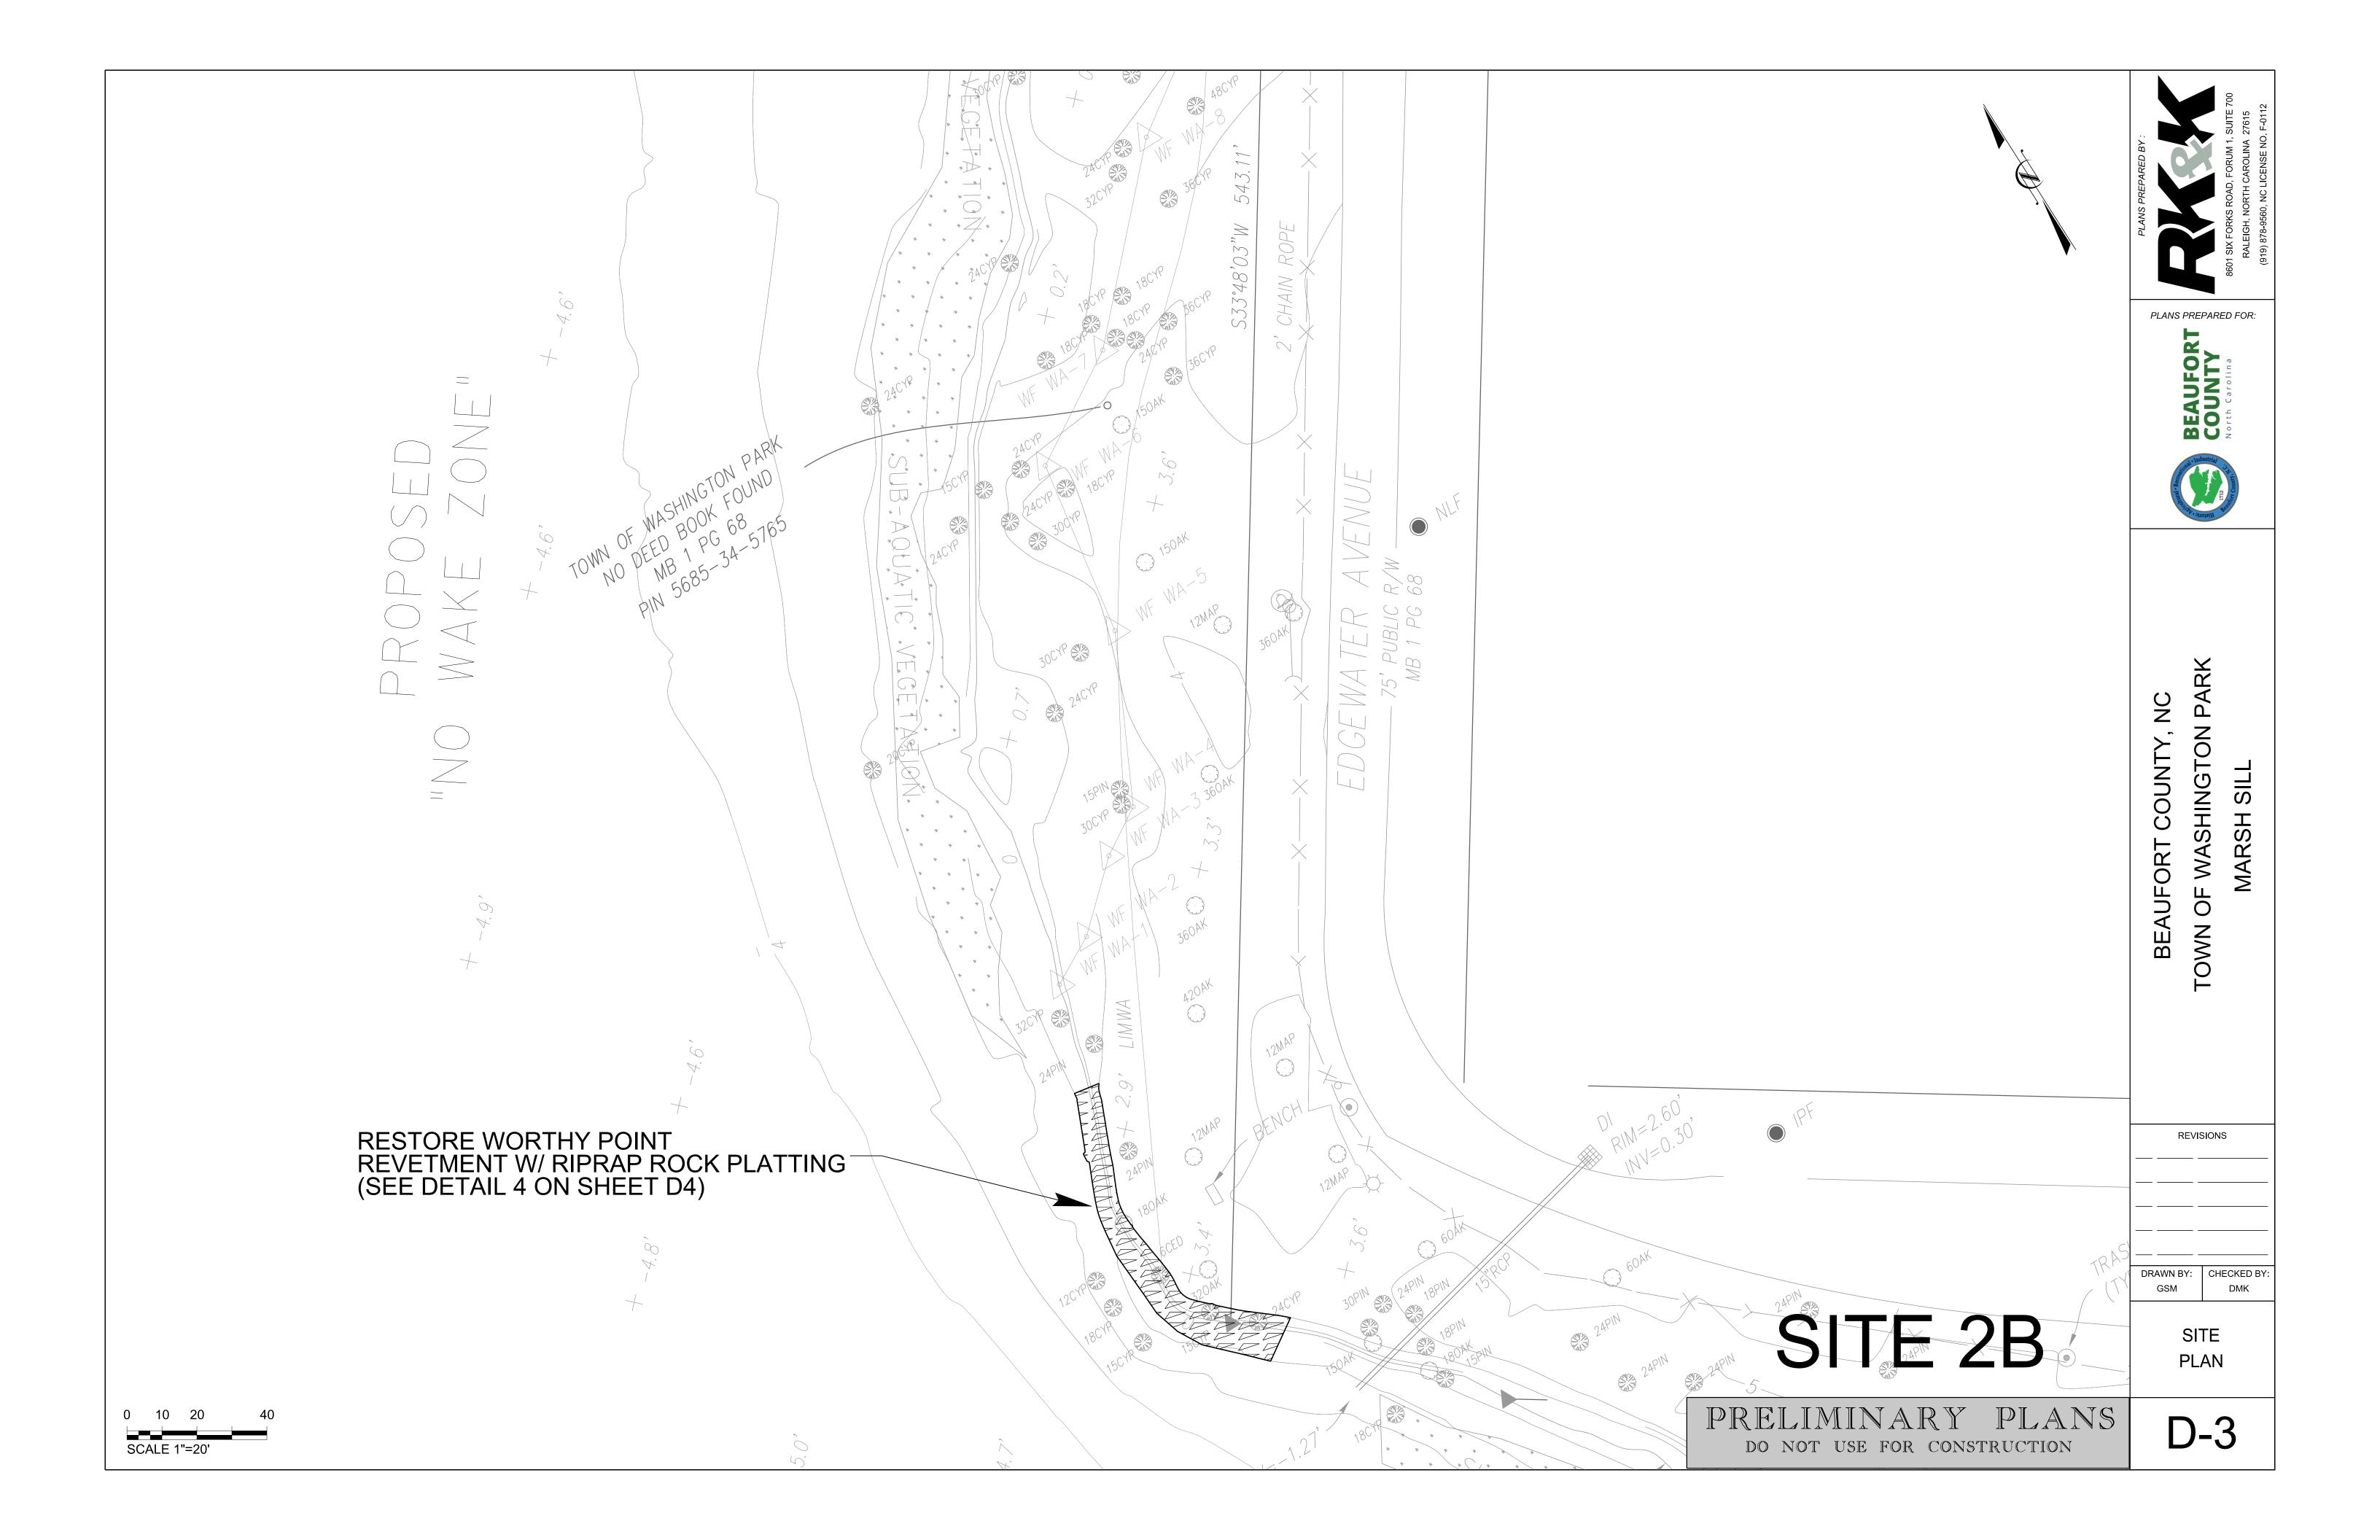
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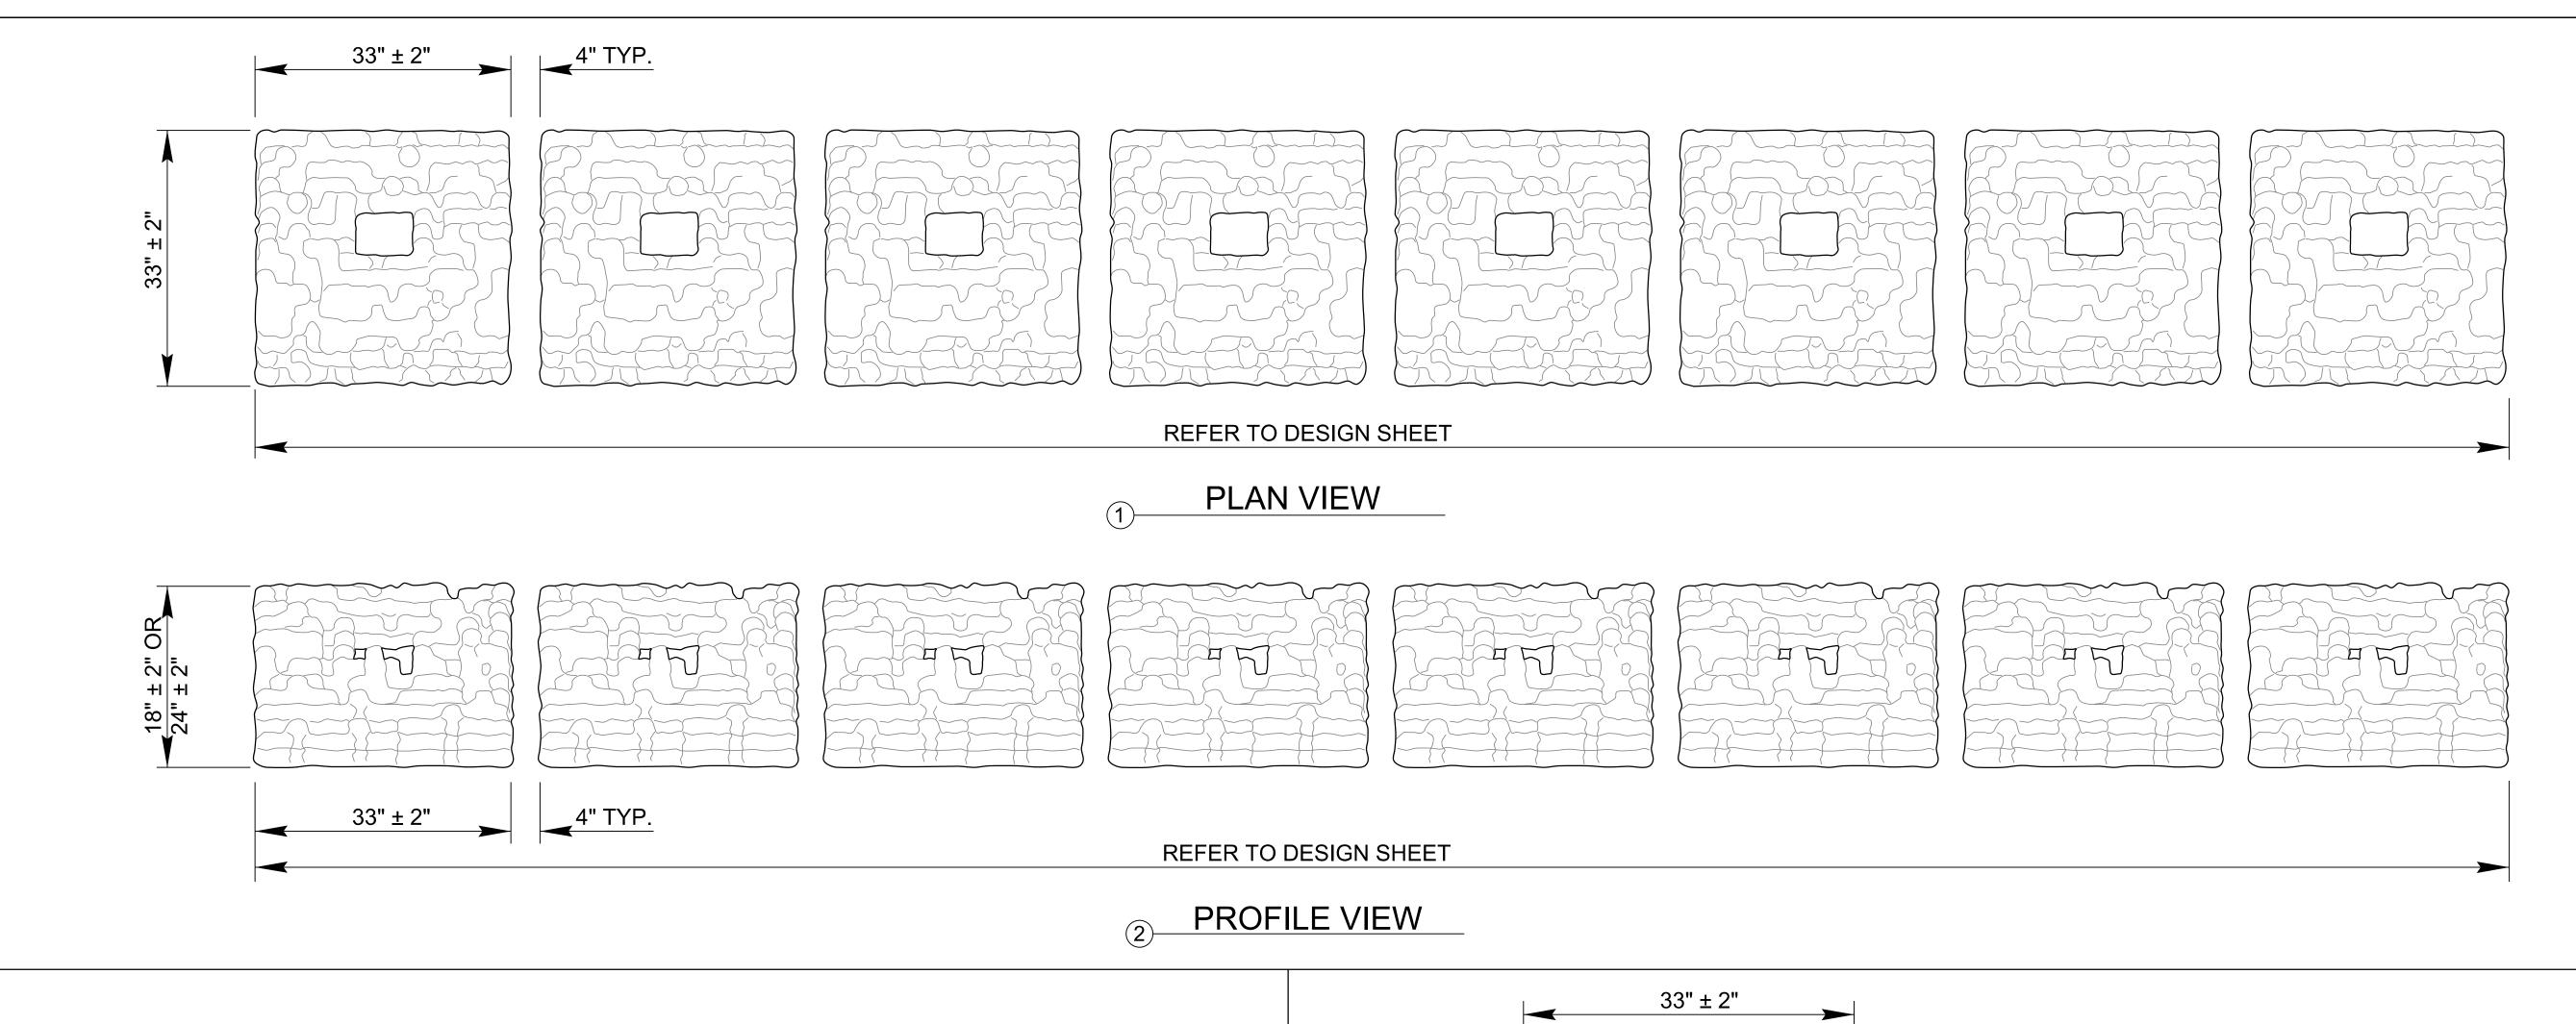
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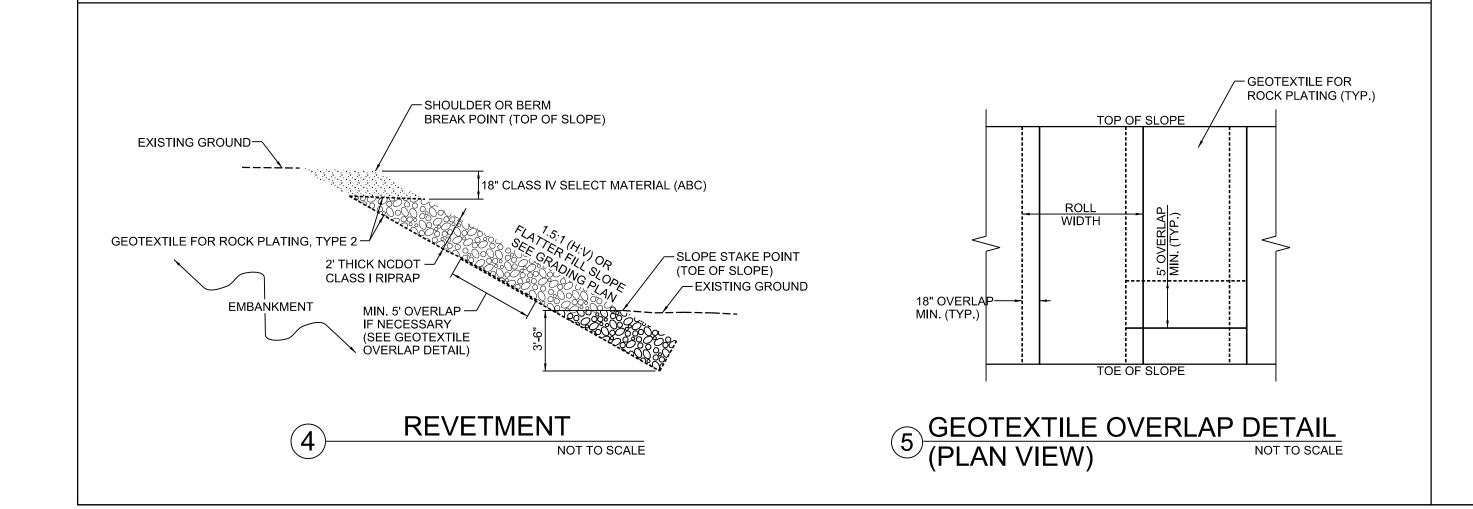





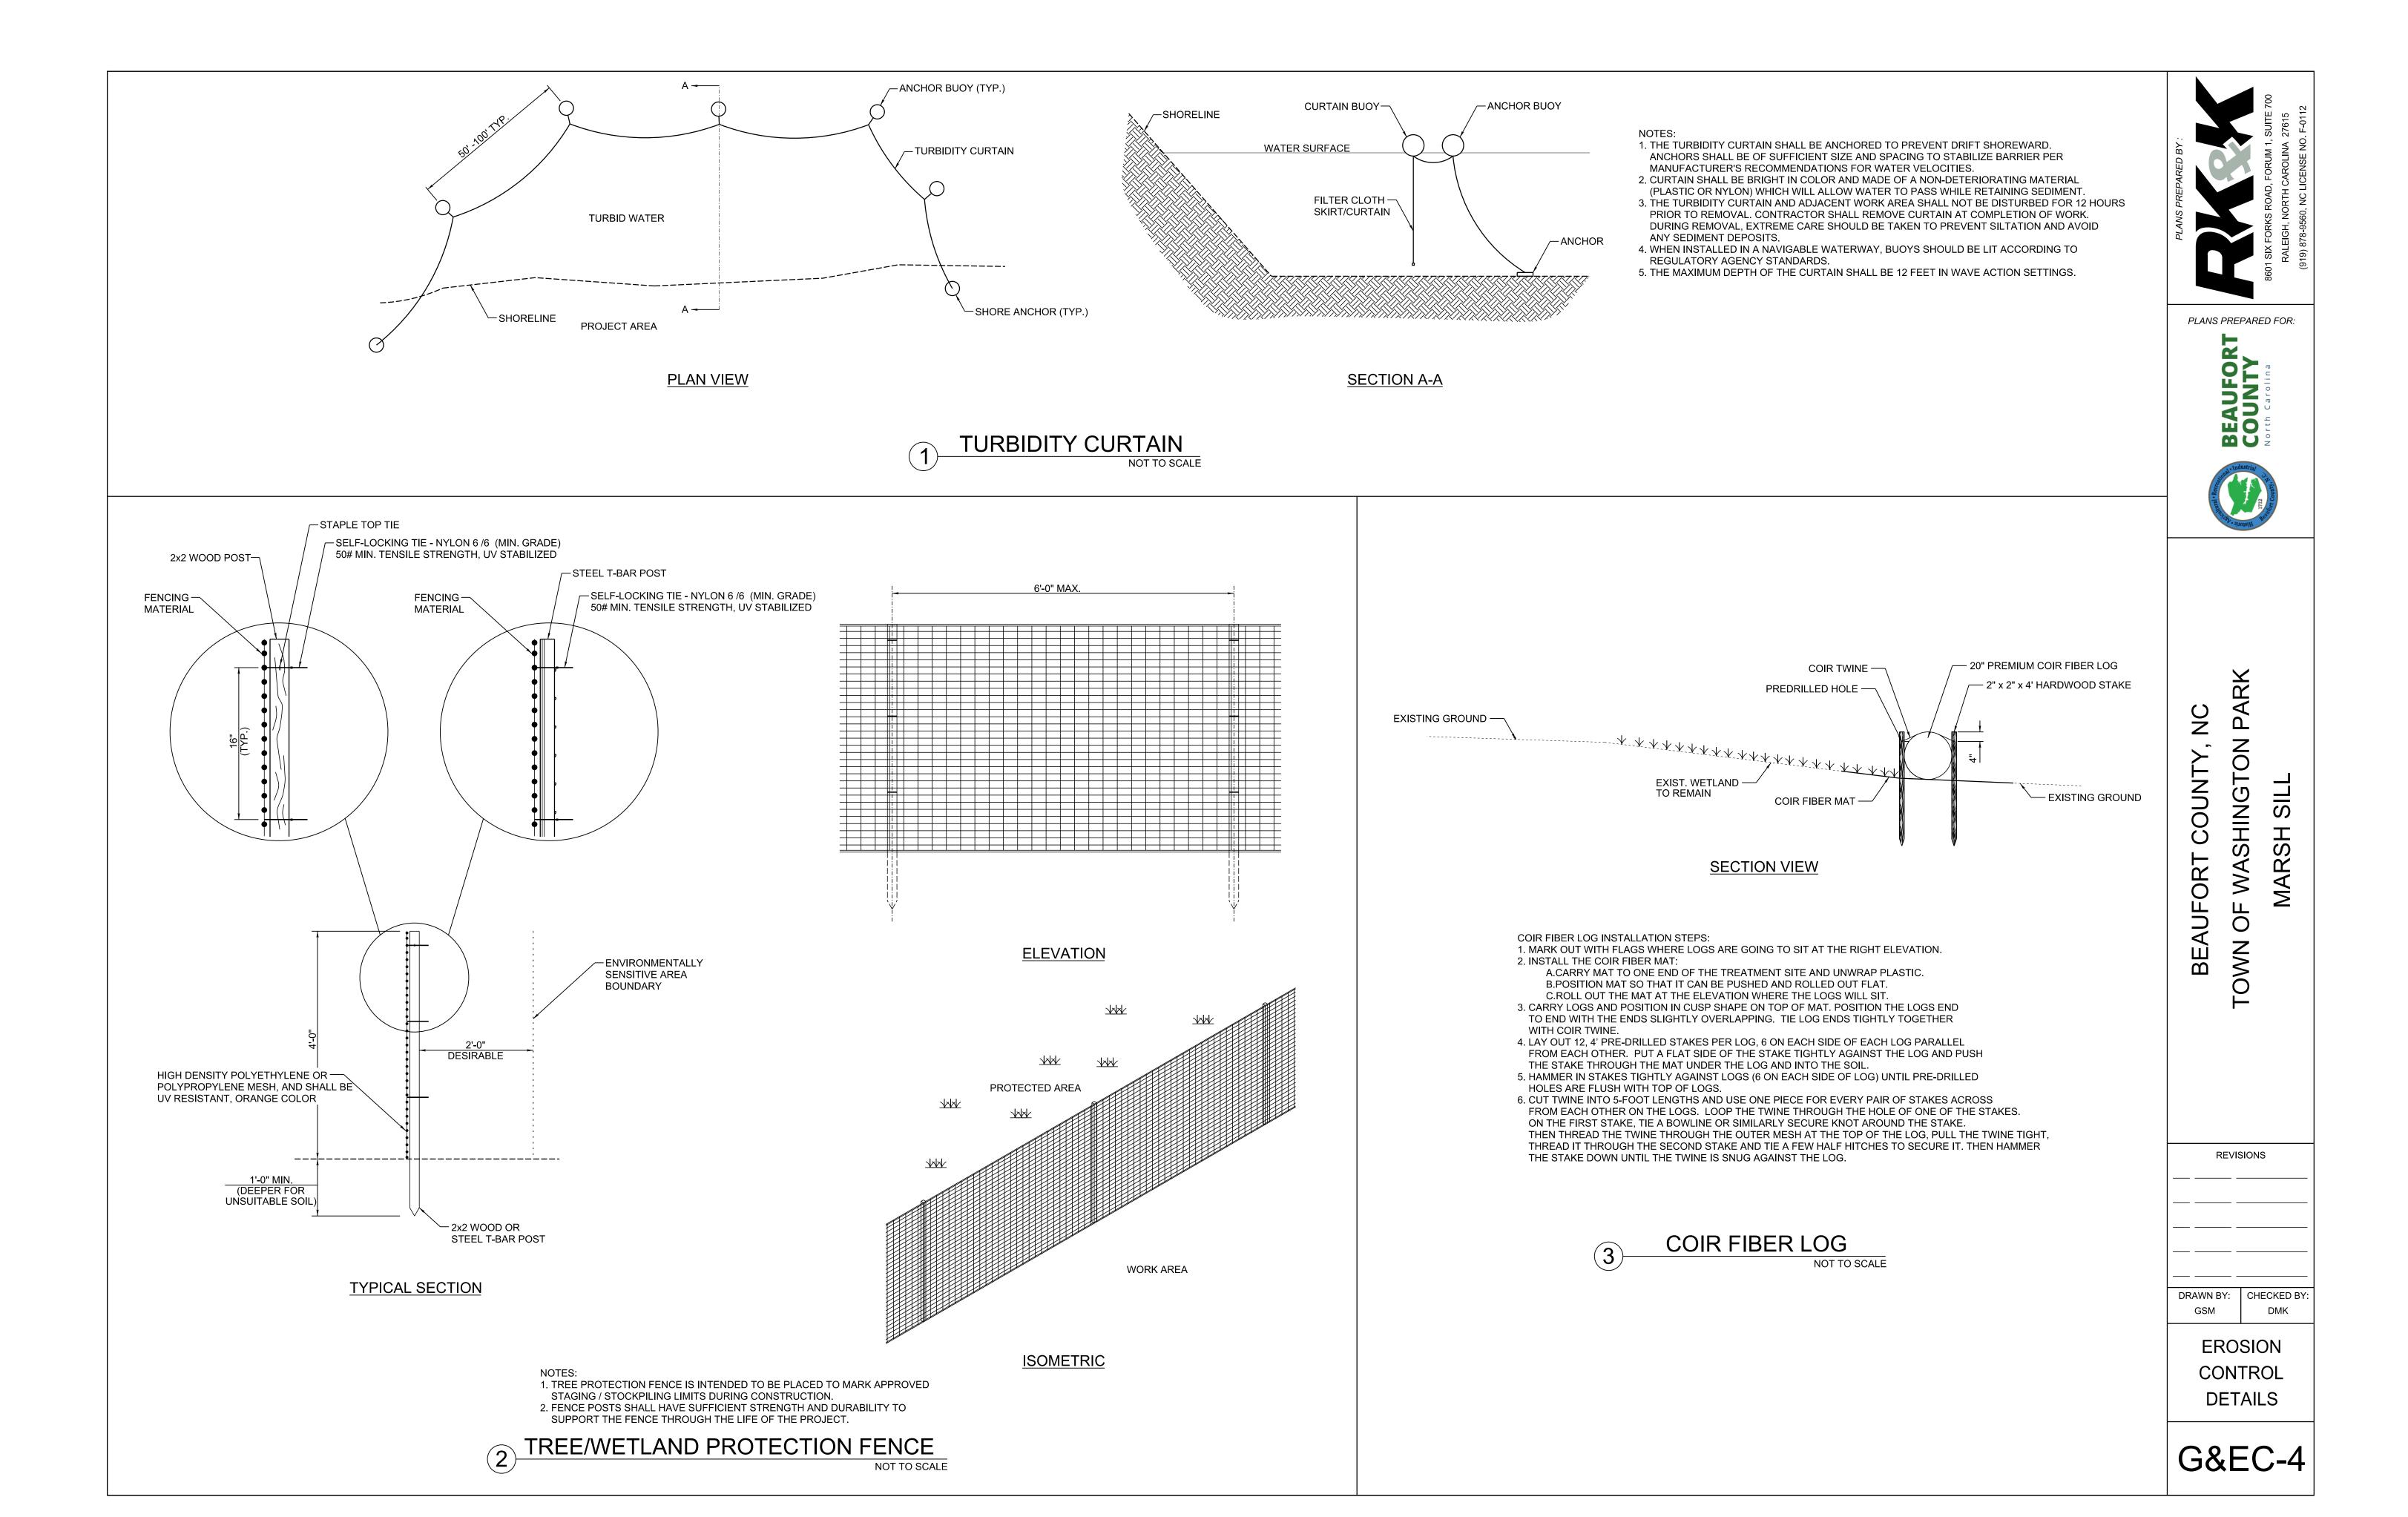

### NOTES:

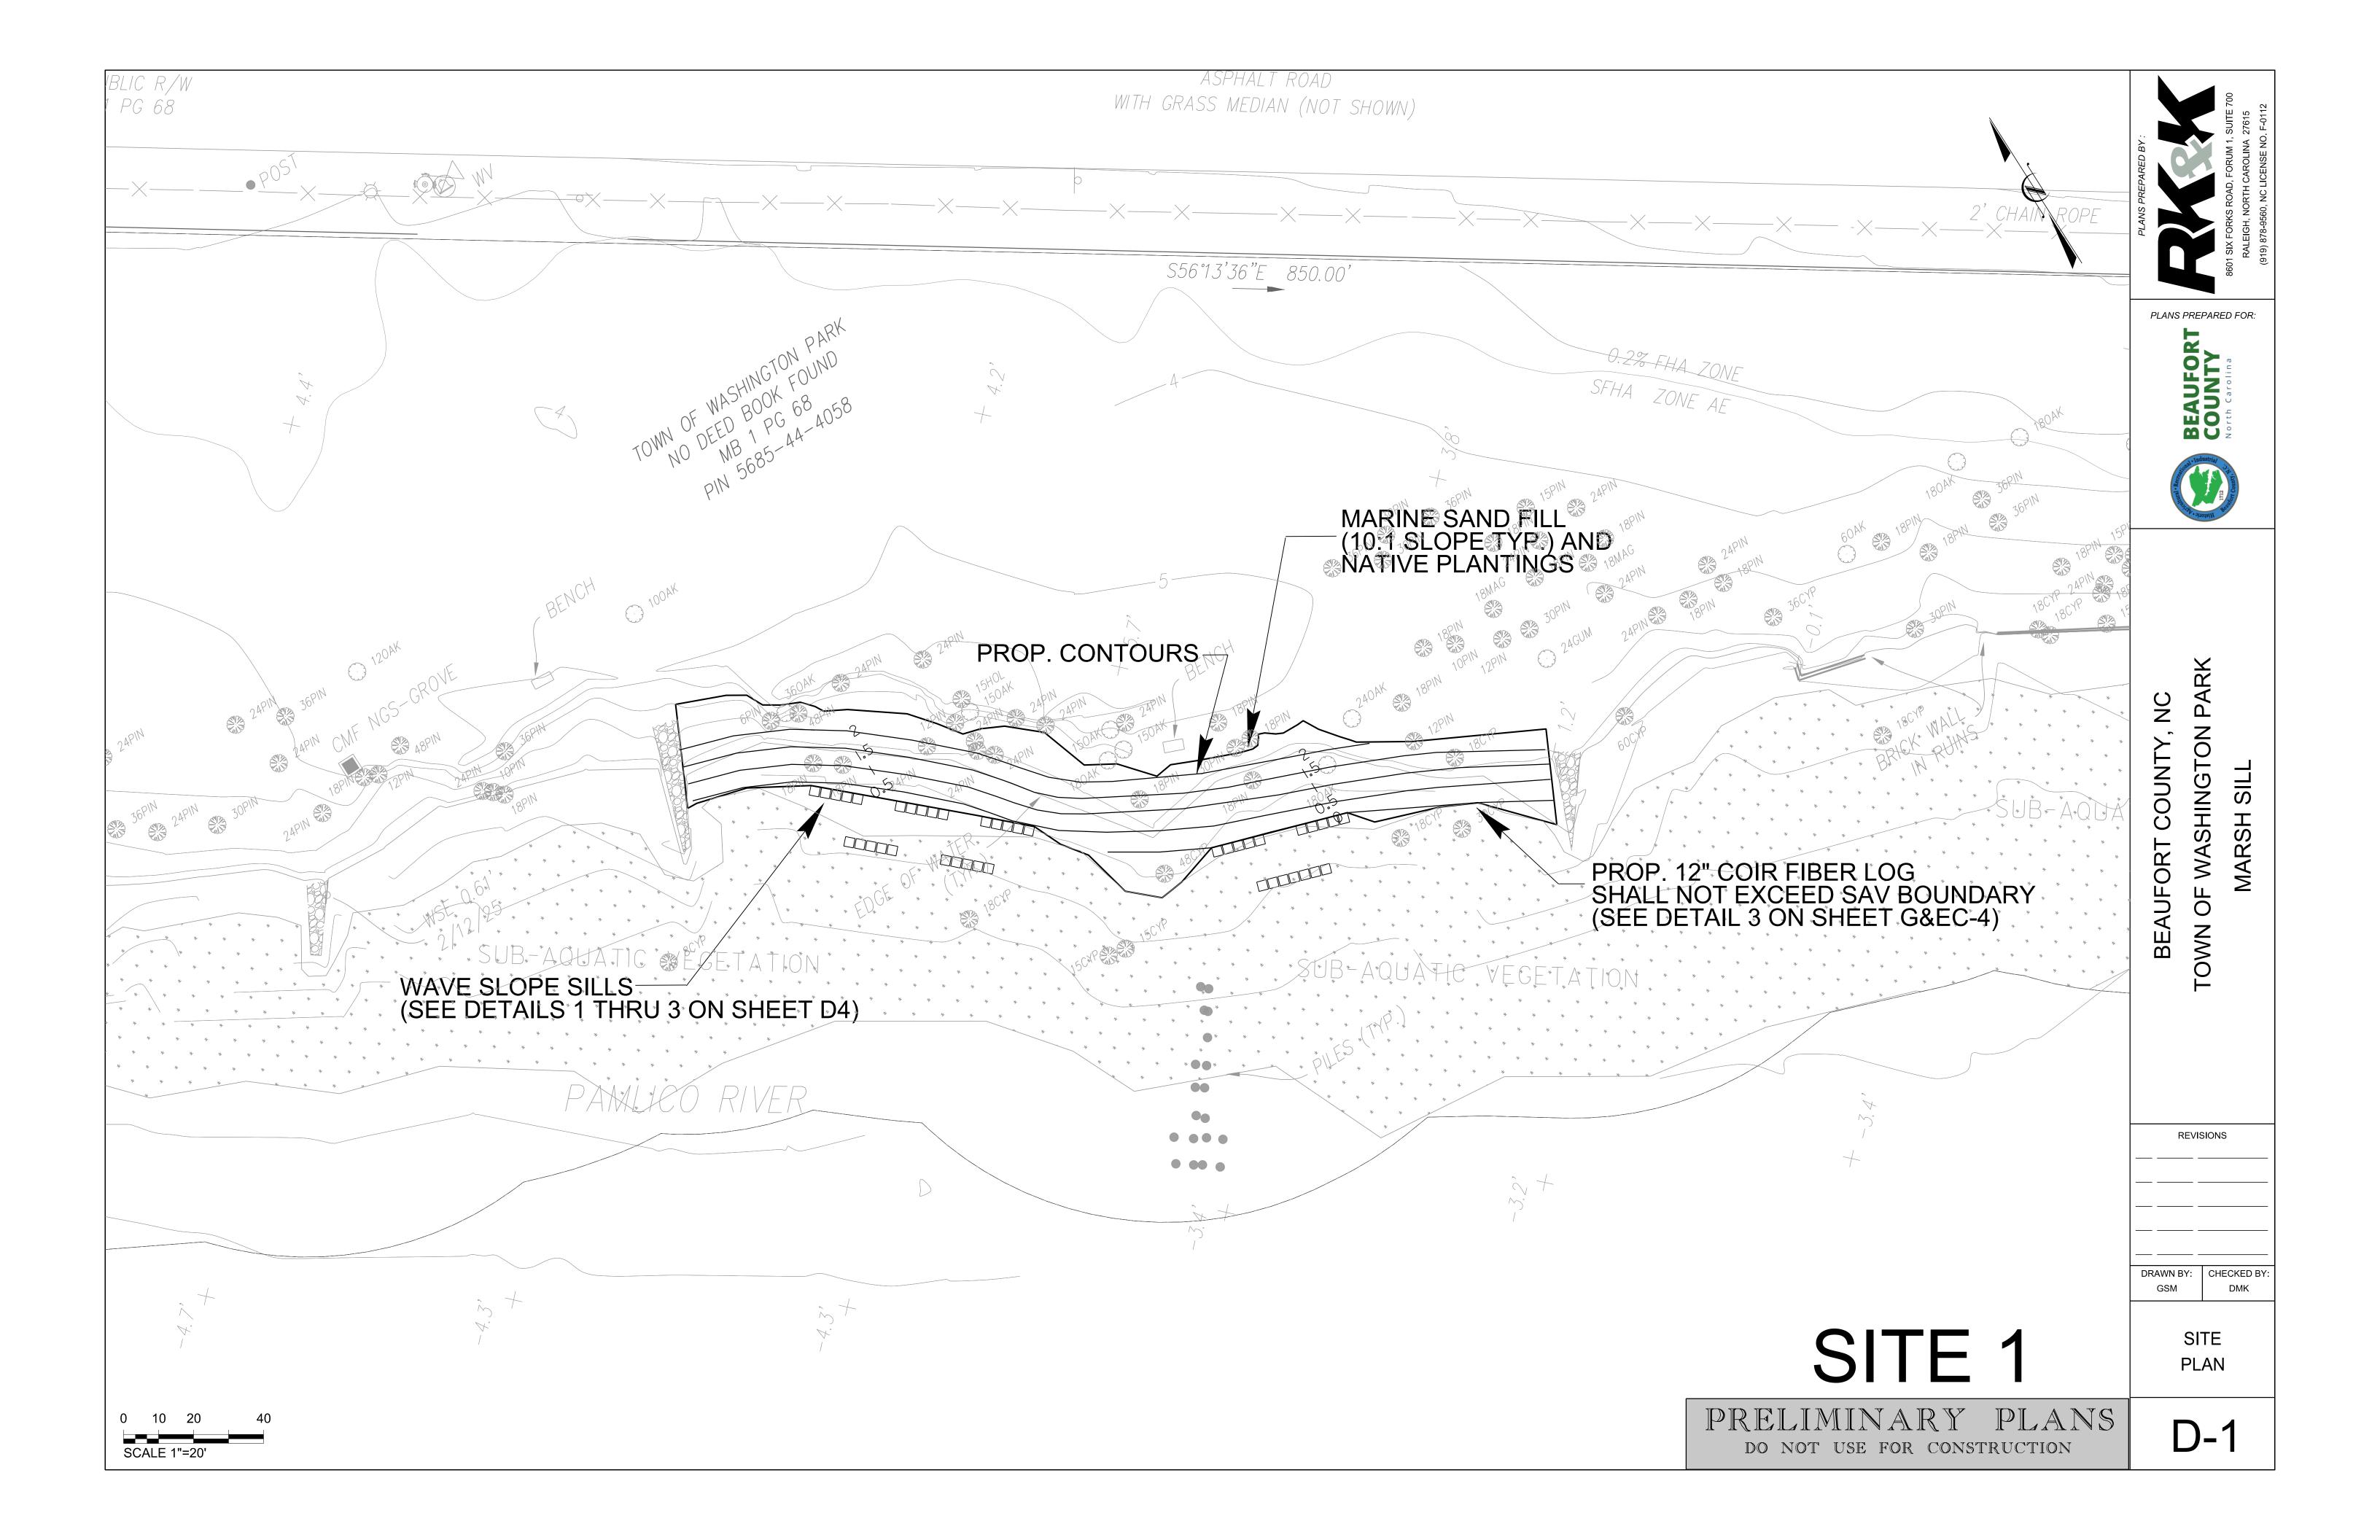- 1. NATRX WAVE SLOPES OR EQUIVALENT ARE TO BE PLACED 4 INCHES APART AT LOCATION SPECIFIED WITHIN THE DESIGN AND ACCORDING TO SPECIAL PROVISION.
- 2. REFER TO SILL DESIGN SHEET FOR SILL LENGTH.
- 3. NO DREDGE OF FILL SHALL OCCUR DURING INSTALLATION OF WAVE SLOPES.
- 4. 18" OR 24" (SHORT WAVE SLOPE) DESIGN SHALL BE INSTALLED PER DESIGN.

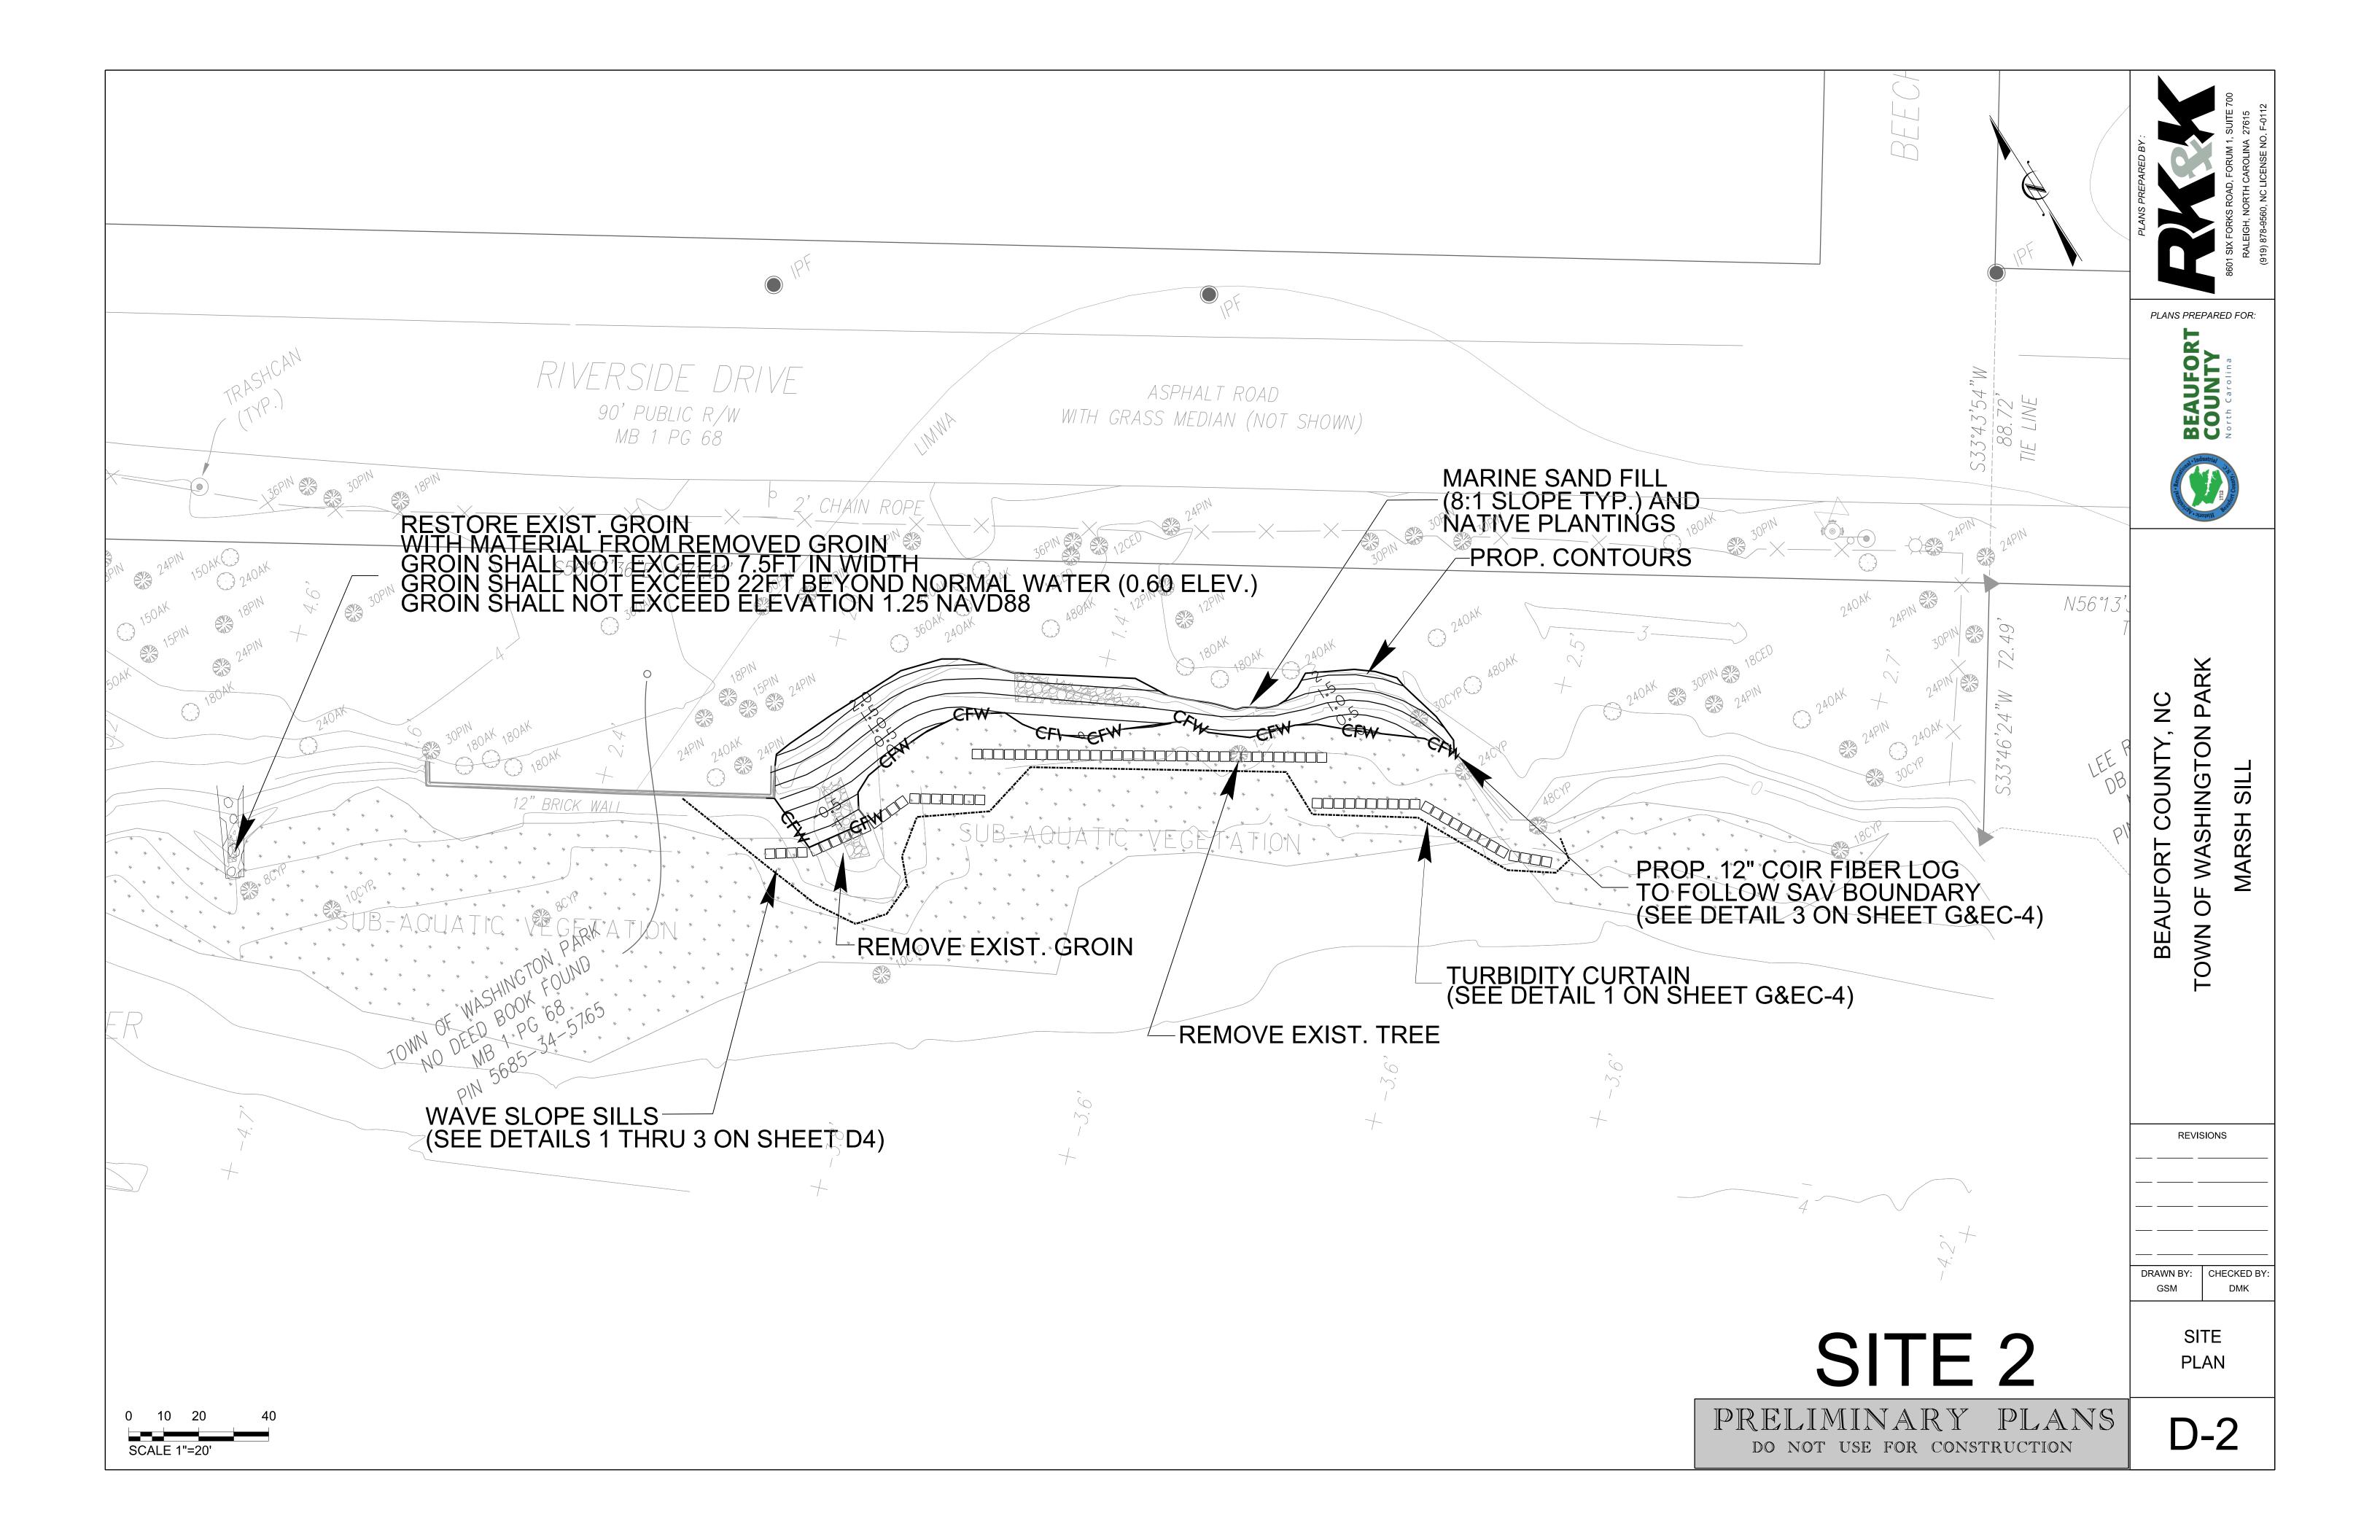

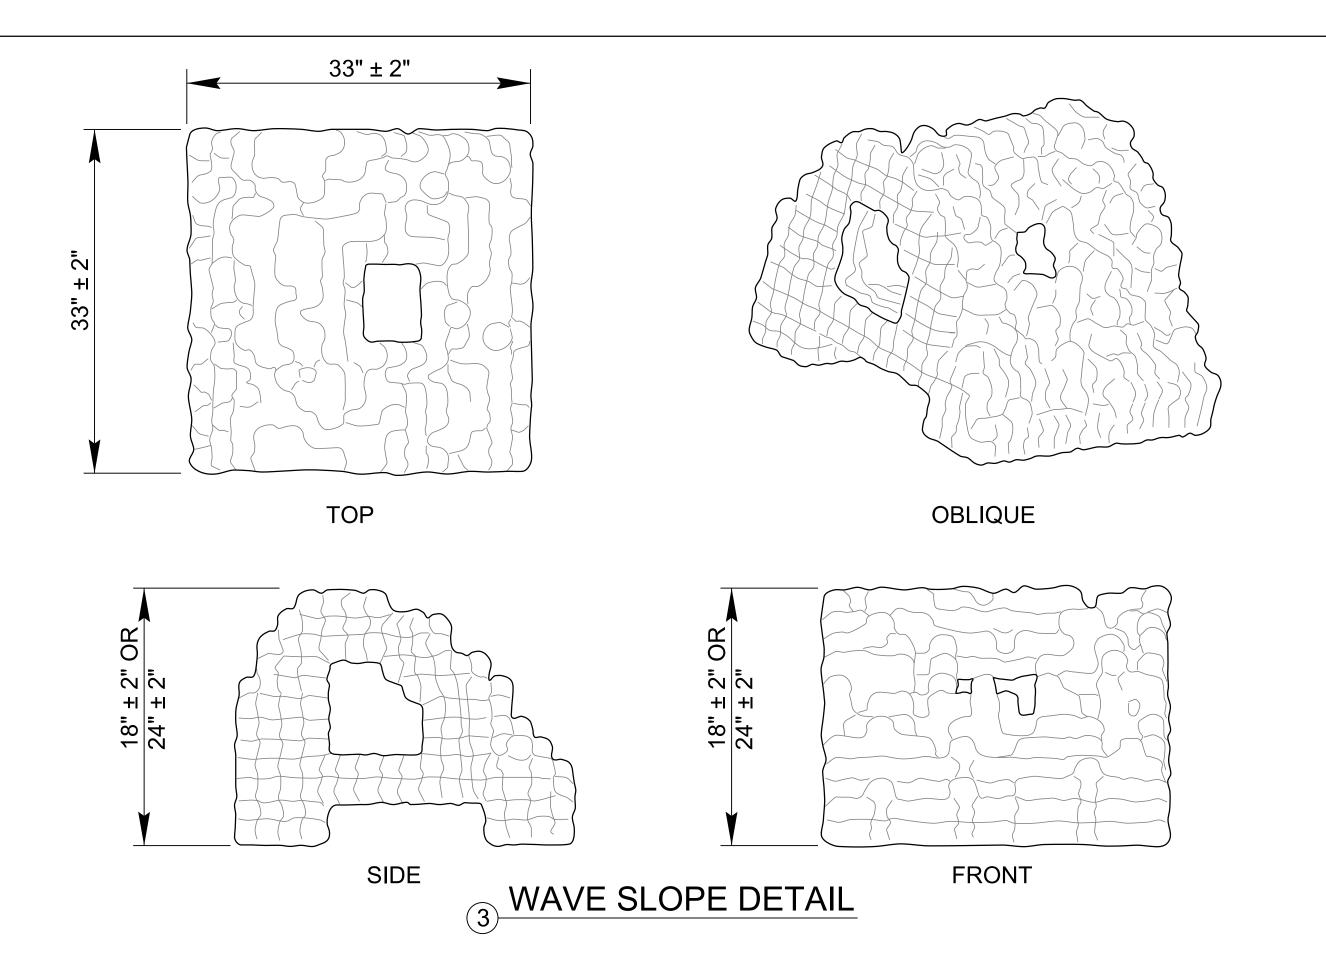

PLANS PREPARED FOR:

BEAUFORT COUNTY North Carolina

**NASHINGTON PA** 

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TOWN

REVISIONS

DRAWN BY: CHECKED BY:

**DETAIL** 

SHEET


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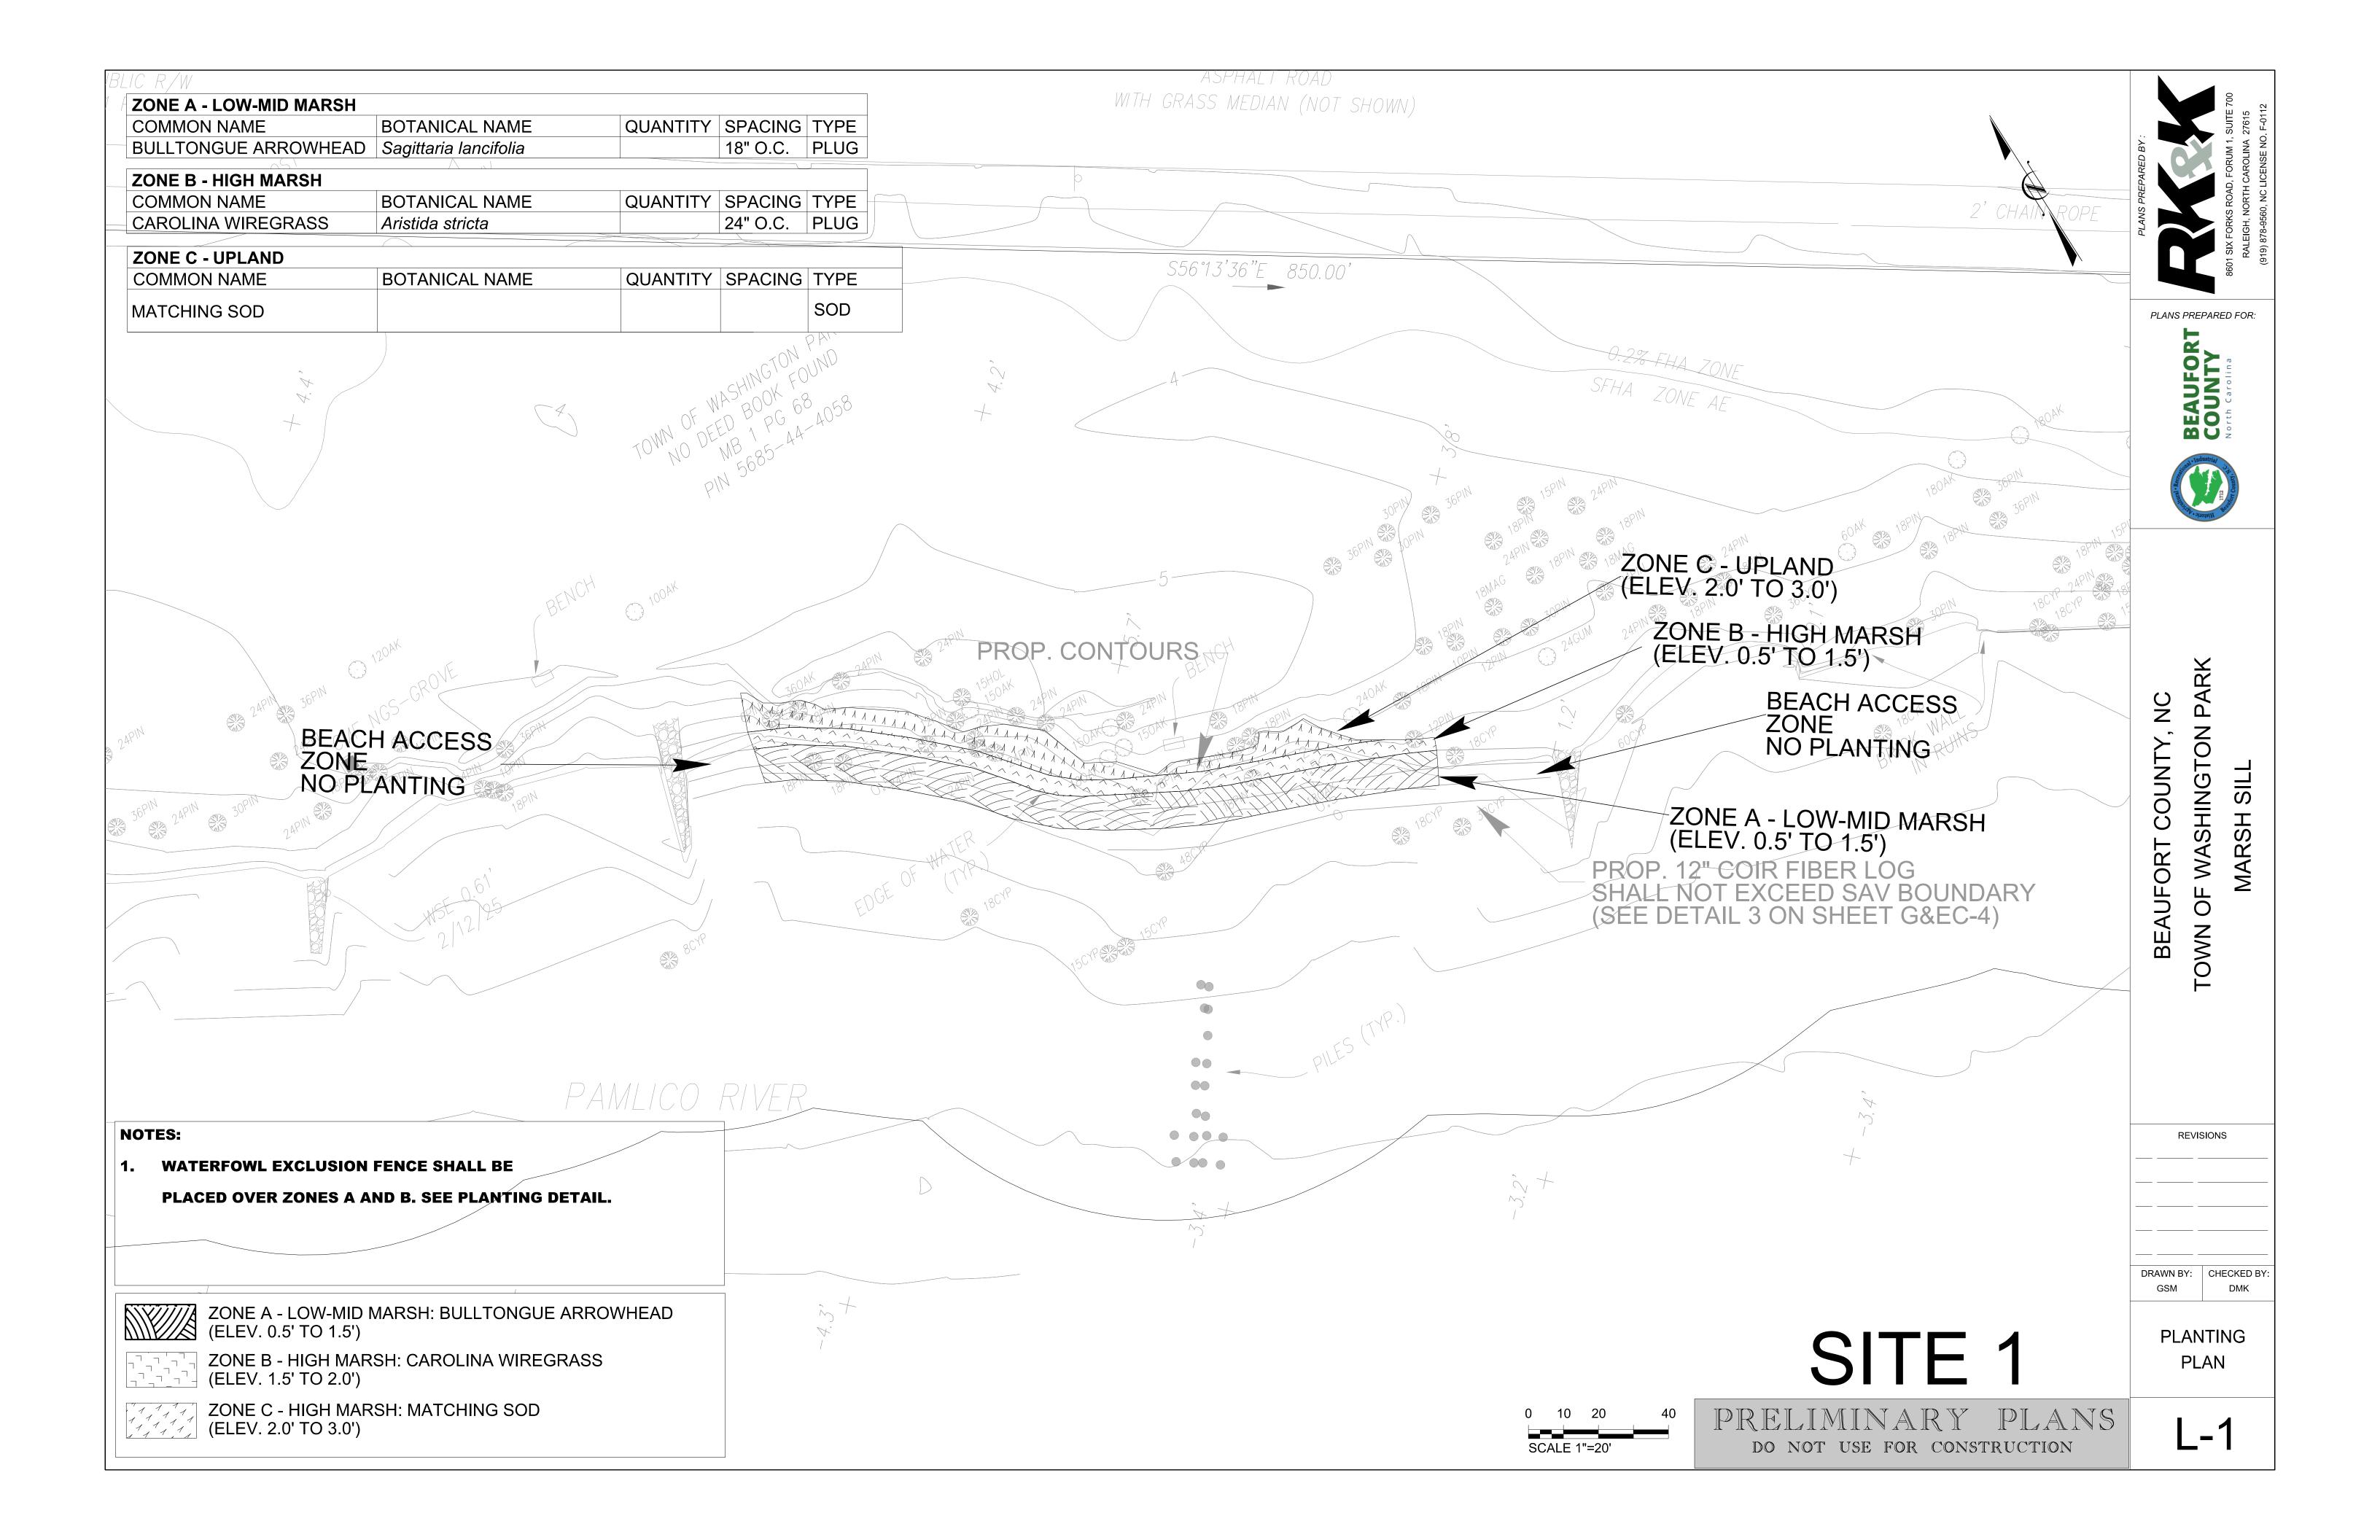
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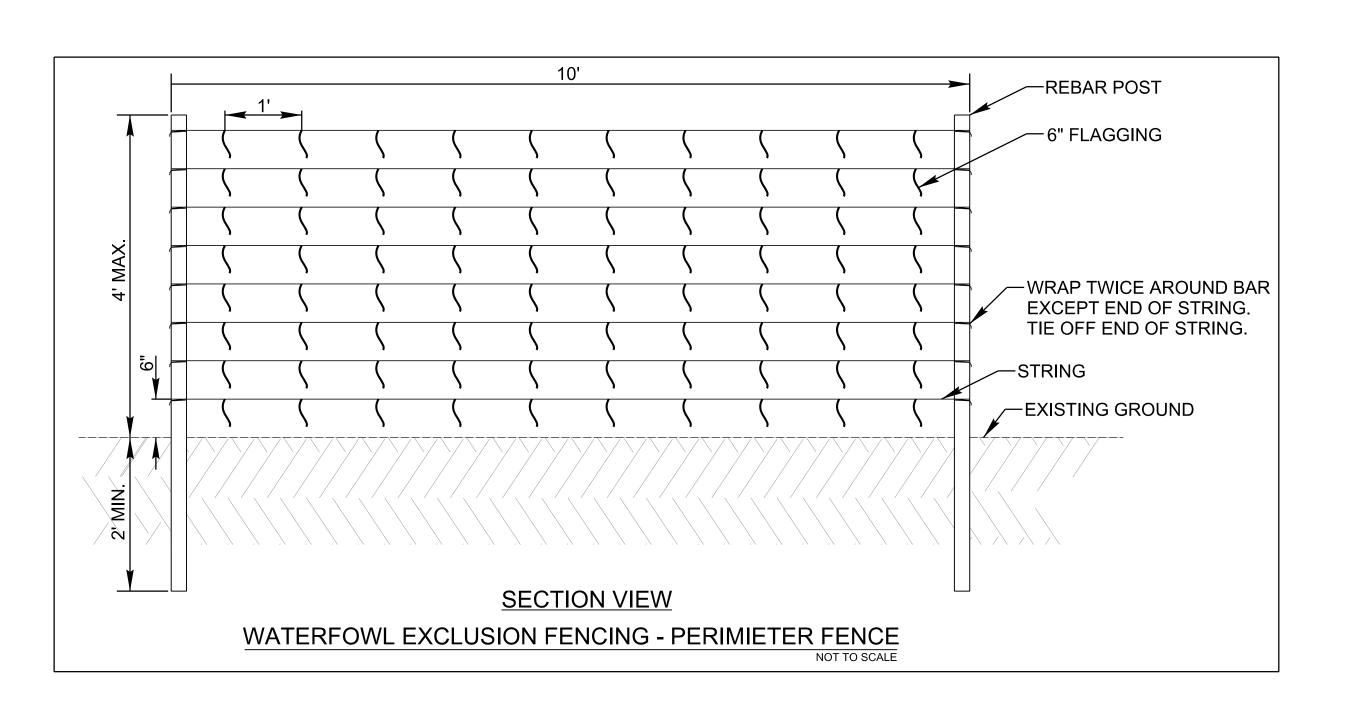
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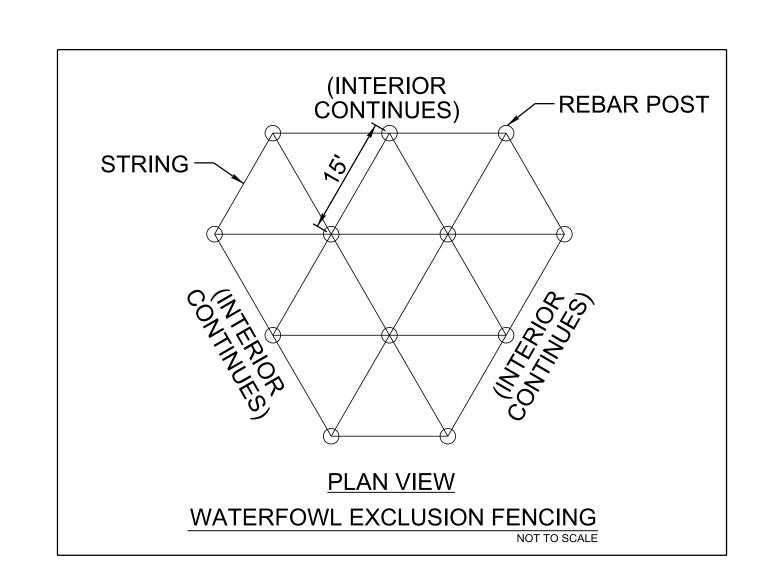
COUNTY, NC


**BEAUFORT** 







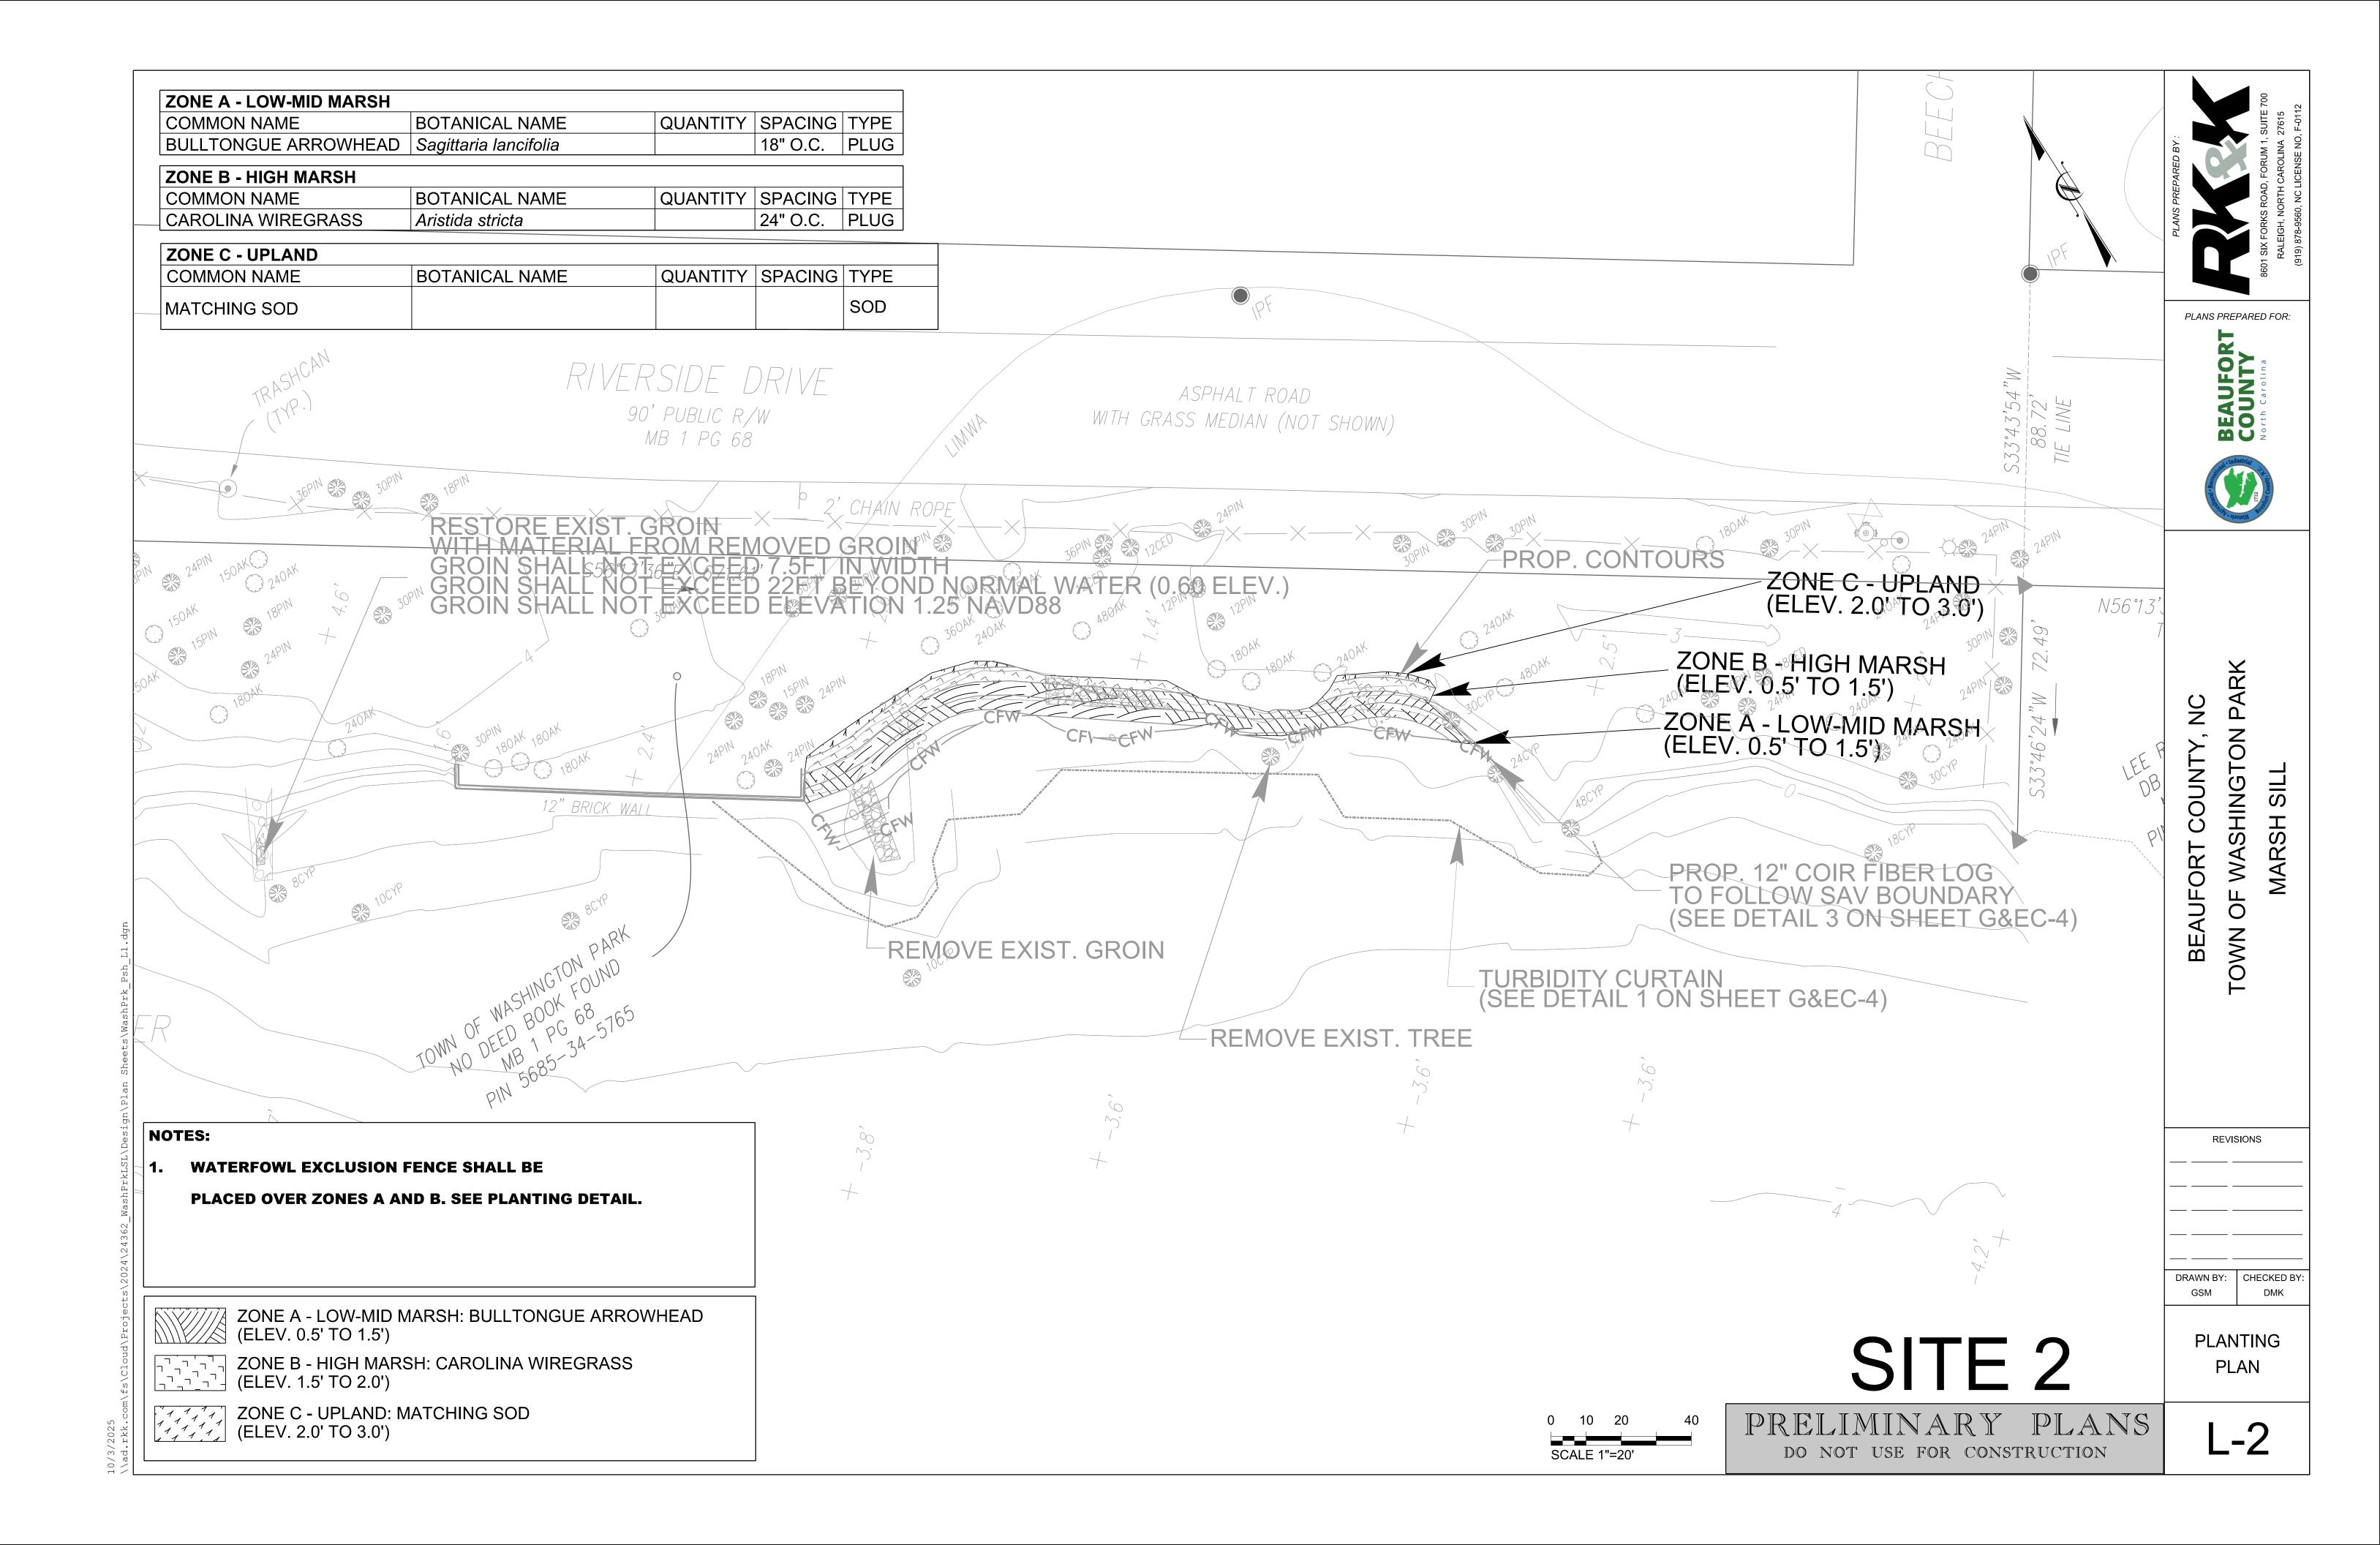

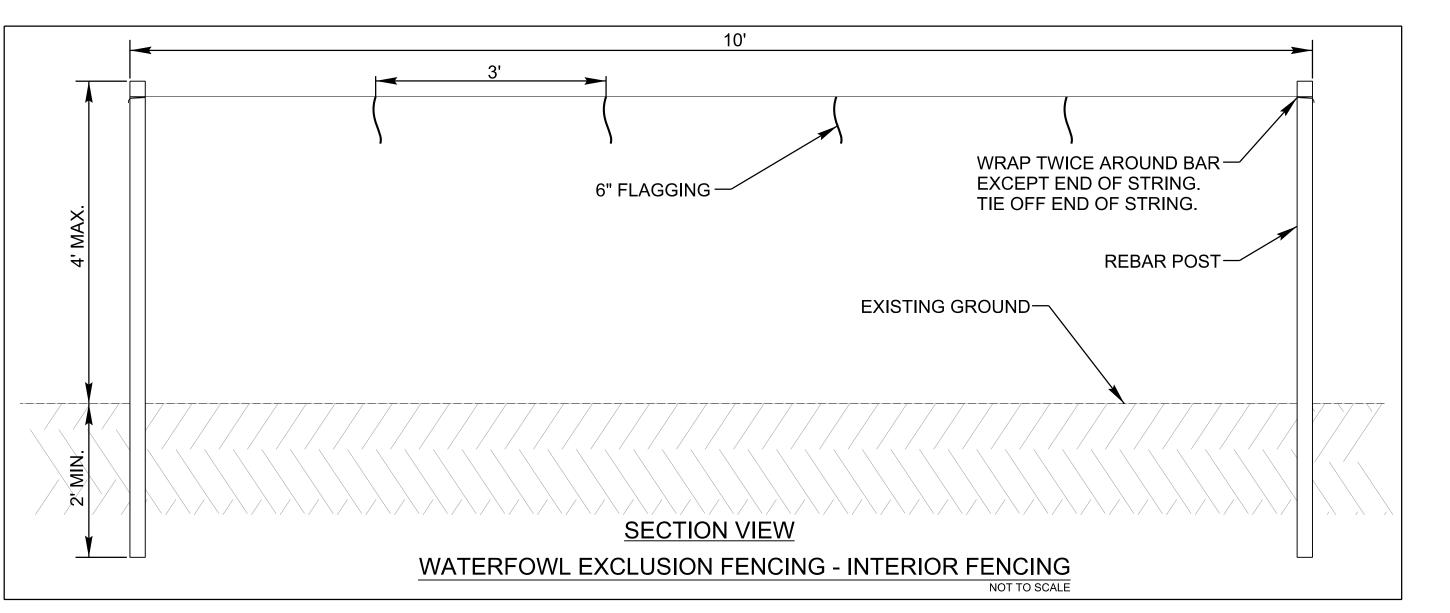







BEAUFORT COUNTY, NC TOWN OF WASHINGTON PARI

DRAWN BY: CHECKED BY:
GSM DMK

PLANTING DETAILS

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